

## NYMNPA

### 04/02/2020

### Document Issue Sheet - planning

job number:	0180_488
job name:	The Bay Tree

		date:
issued to:	company:	
Jill Bastow	North York Moors National Park	

## issued by

checked by

media type : P = Paper Copy E = Email CD = Compact Disc

purpose of issue : I = Information A = Approval T = Tender C = Construction


document no:	title:	size:	scale:
Existing			
0180_488_PL_001	Location Plan	A3	1:1250
0180_488_PL_002	Existing Site Plan	A3	1:200
0180_488_PL_010	Existing Ground Floor Plan	AЗ	1:100
0180_488_PL_011	Existing First Floor Plan	AЗ	1:100
0180_488_PL_012	Existing Second Floor Plan	AЗ	1:100
0180_488_PL_013	Existing Roof Plan	AЗ	1:100
0180_488_PL_014	Alterations: Existing Ground Floor Plan	AЗ	1:100
0180_488_PL_015	Alterations: Existing First Floor Plan	AЗ	1:100
0180_488_PL_040	Existing Elevations 01 & 02	AЗ	1:100
0180_488_PL_041	Existing Elevations 03 & 04	AЗ	1:100
0180_488_PL_042	Existing Elevations 05, 06 & 07	AЗ	1:100
0180_488_PL_050	Existing Sections	AЗ	1:100
Proposed			
0180_488_PL_100	Proposed Site Plan	AЗ	1:200
0180_488_PL_110	Proposed Ground Floor Plan	AЗ	1:100
0180_488_PL_111	Proposed First Floor Plan	AЗ	1:100
0180_488_PL_112	Proposed Roof Plan	AЗ	1:100
0180_488_PL_400	Proposed Street Elevations	Aз	1:200
0180_488_PL_410	Proposed Elevations 01	AЗ	1:100
0180_488_PL_411	Proposed Elevations 02	Aз	1:100
0180_488_PL_412	Proposed Elevations 03	Aз	1:100
0180_488_PL_413	Proposed Elevations 04	AЗ	1:100
0180_488_PL_500	Proposed Section A-A	AЗ	1:100
0180_488_PL_501	Proposed Section B-B	AЗ	1:100
0180_488_PL_502	Proposed Section C-C	AЗ	1:100
0180_488_PL_600	Proposed Bay Elevation	AЗ	1:50
0180_488_PL_601	Proposed Bin Store	Aз	1:50
0180_488_PL_900	Illustrative View 01	AЗ	n/a
0180_488_PL_901	Illustrative View 02	A3	n/a
0180_488_PL_902	Illustrative View 03	AЗ	n/a
0180 488 DAS	Design & Access Statement	A3	n/a

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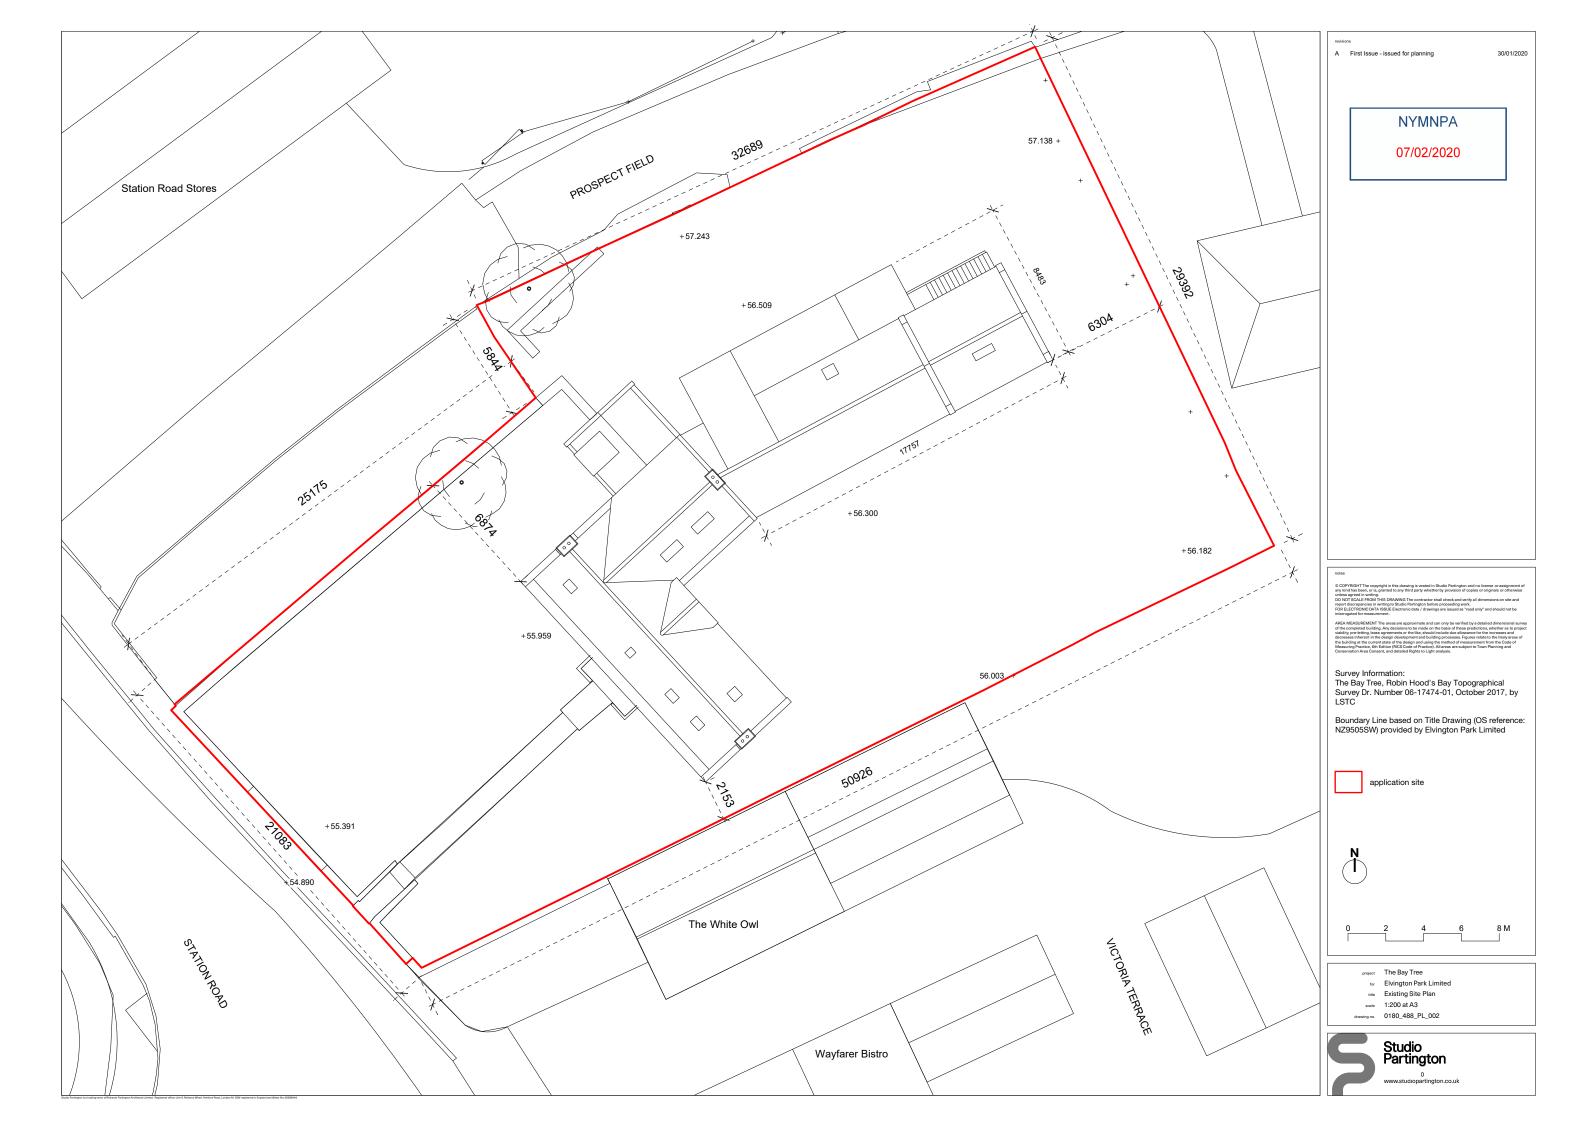
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Directors: Adam Convish, Colin Davis, Victoria Kirk & Richard Partington Studio Partington is a trading nume of Richards Parlington Architects Limited, Registered Office: Unit G Relance Whart, Hertford Road, London N1 SEW. Registered in England & Wales No: 5585646





Revisions           A         First Issue - issued for planning           B         Site boundary line adjusted to match title drawing	30/01/2020 19/02/2020
NYMNPA	7
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notes © Comparison of the second se	
application site	
0 10 20 30 40 M	Ň
project The Bay Tree ter Elvington Park Limited time Location Plan scale 1:1250 at A3 drawing no. 0180_488_PL_001B	
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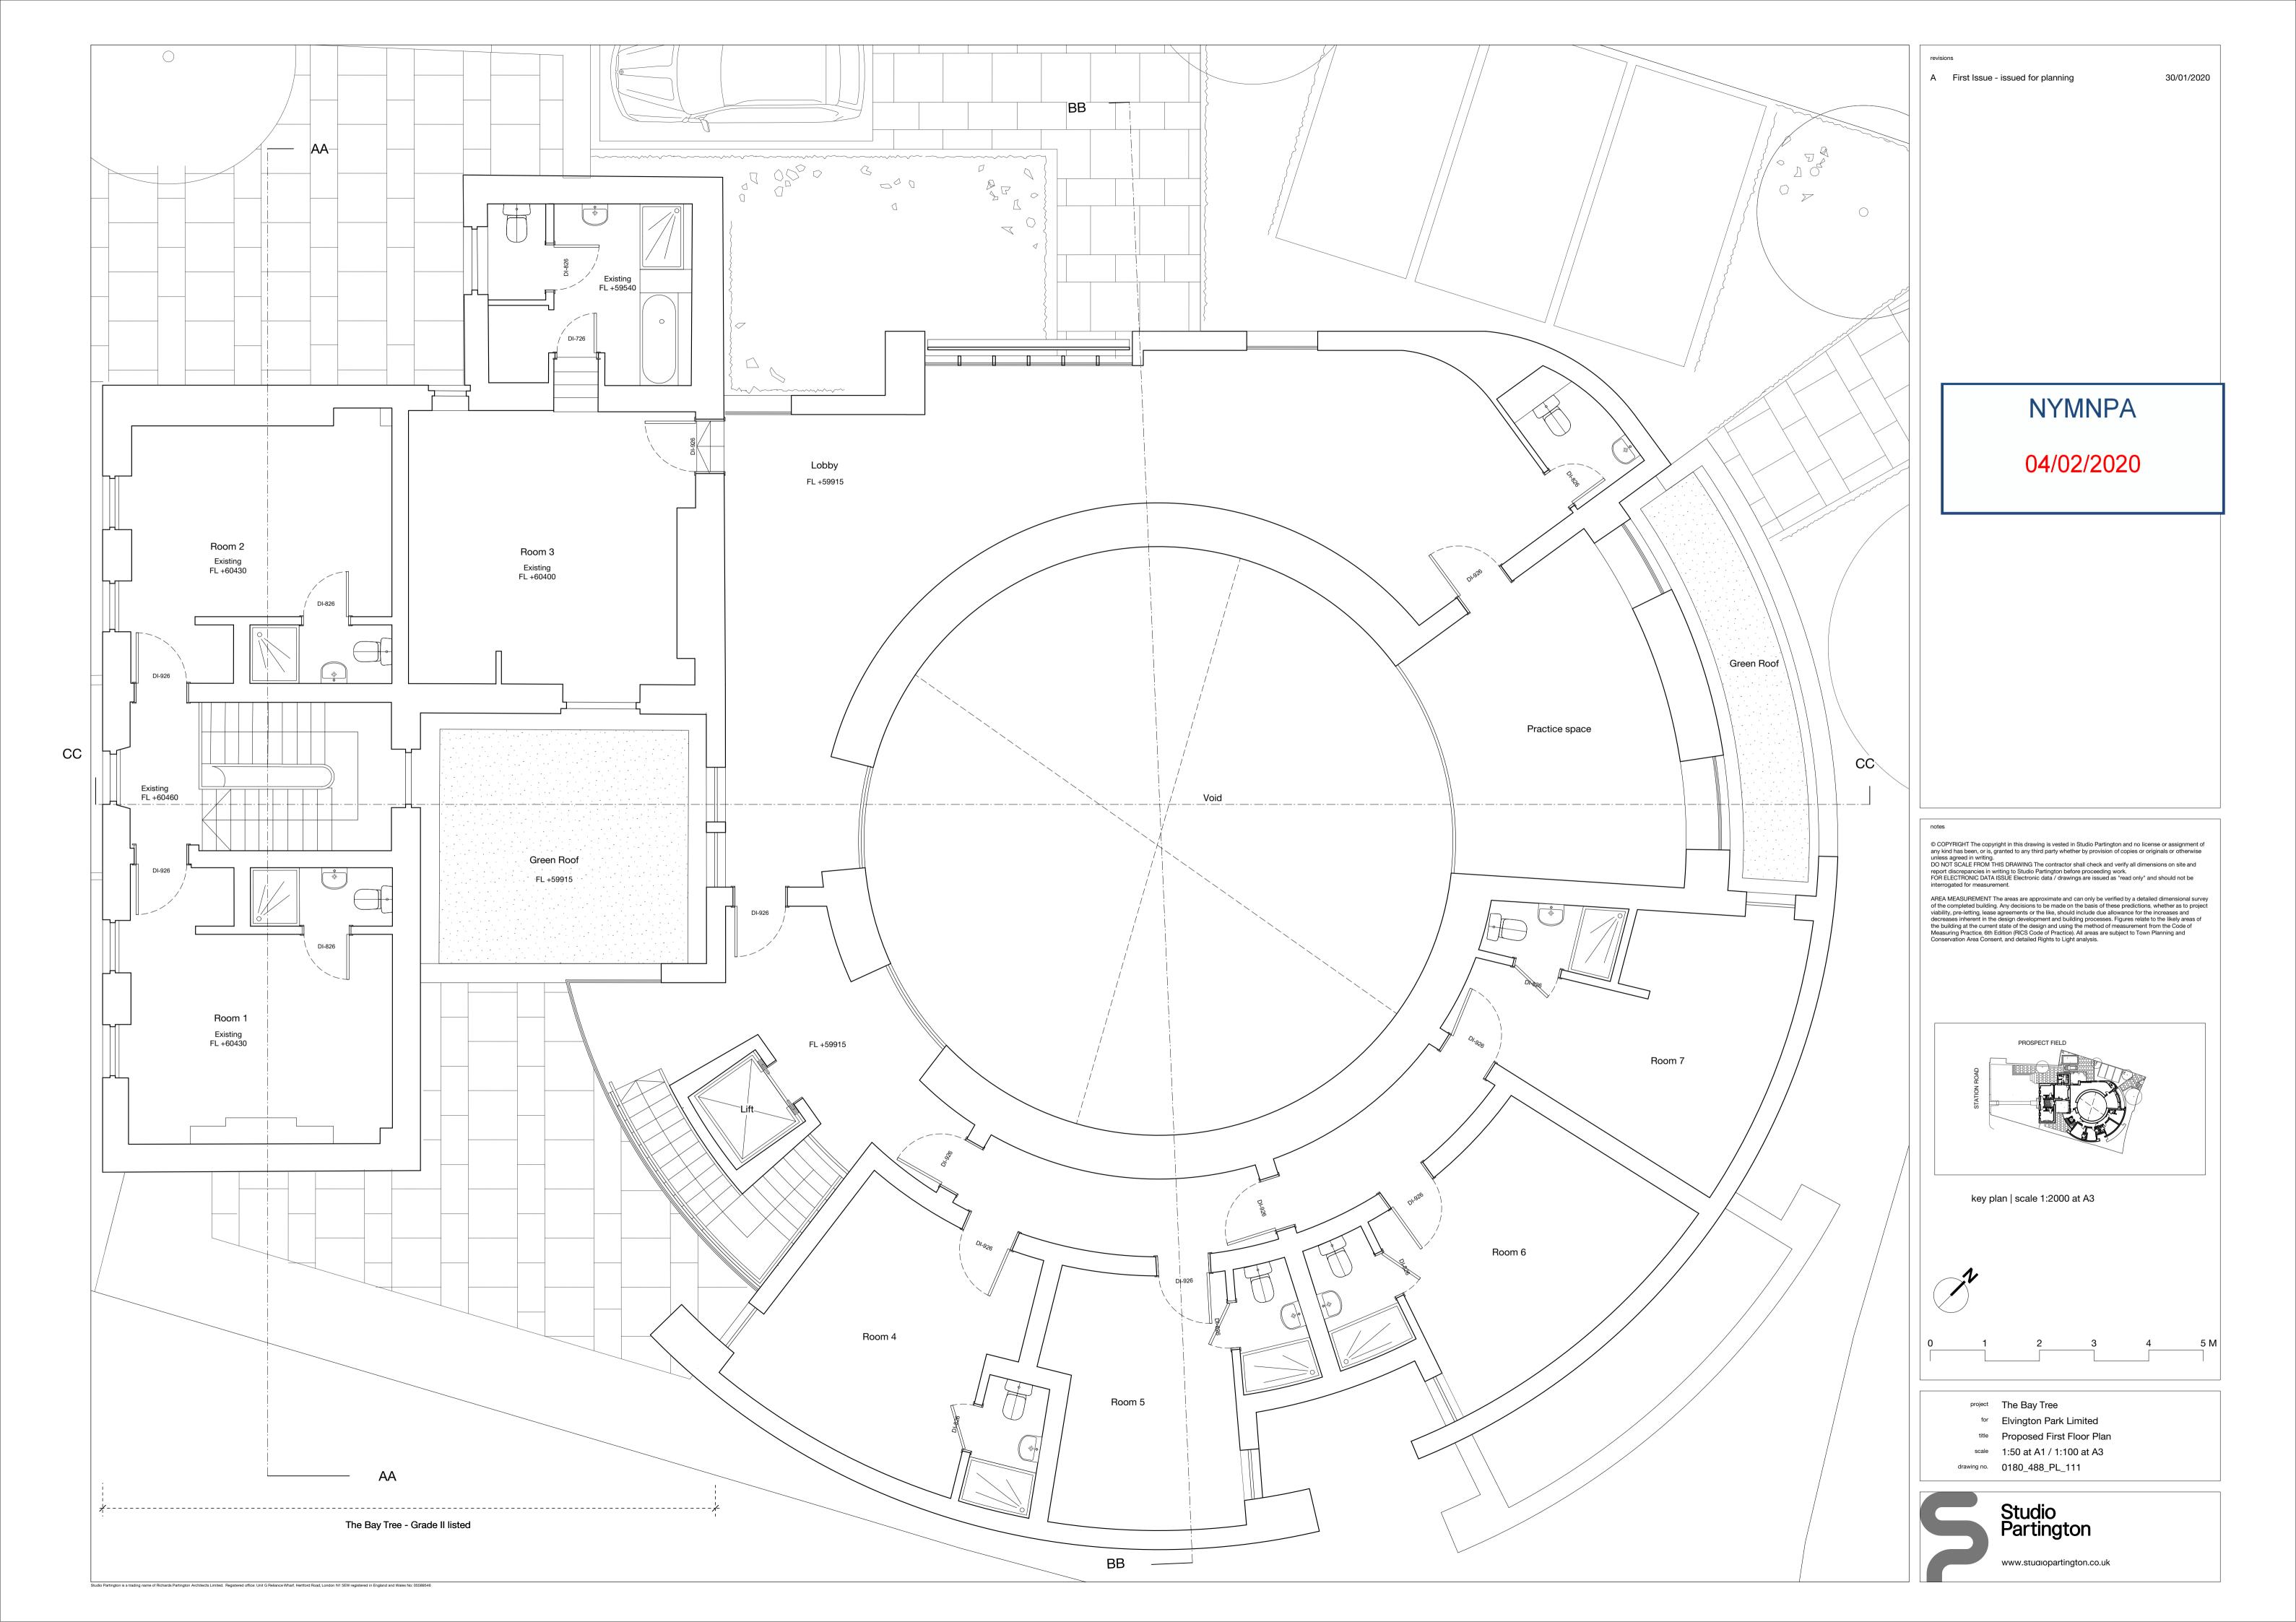





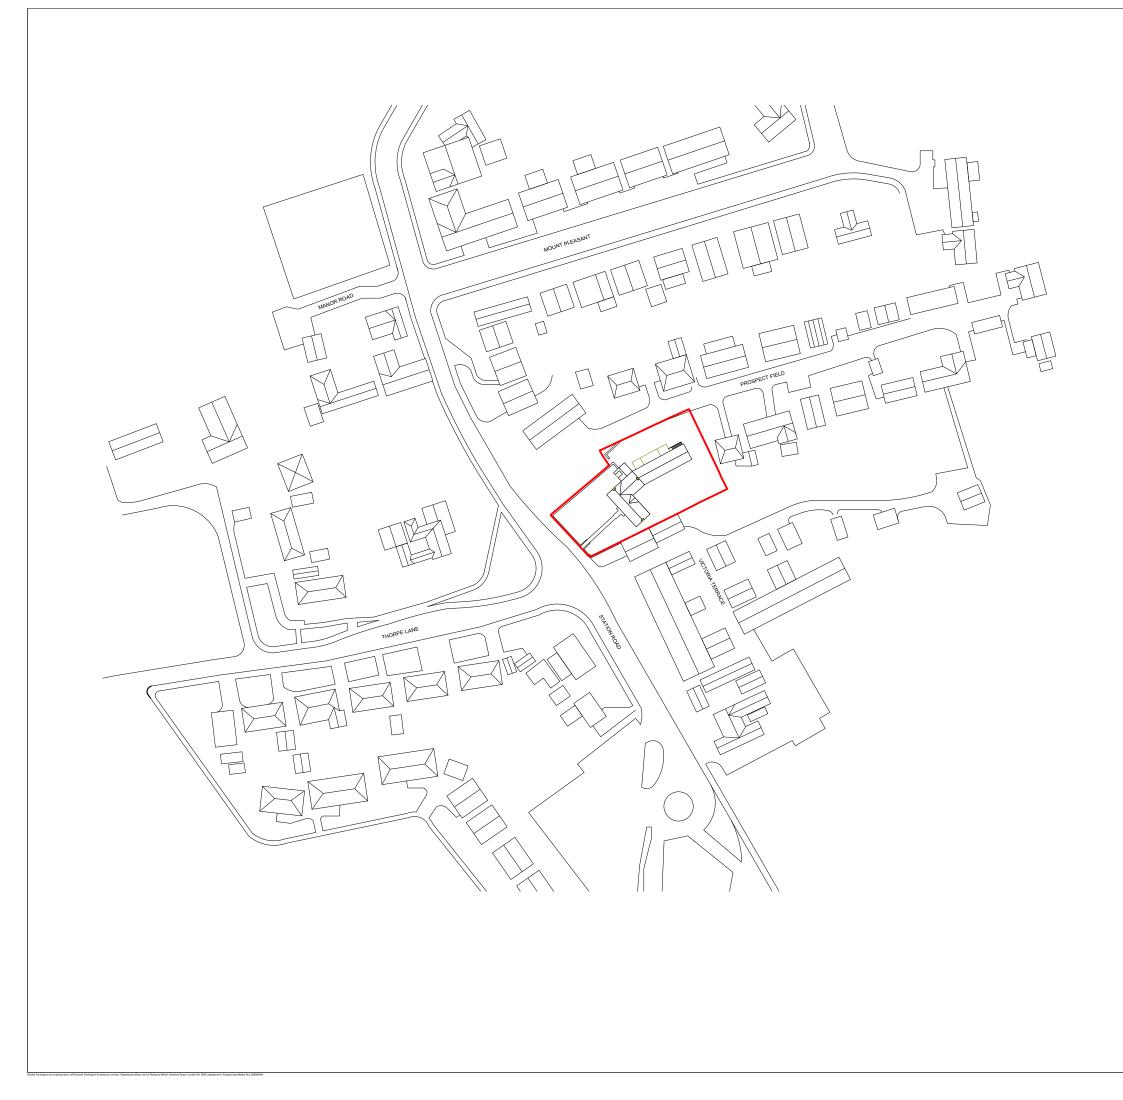




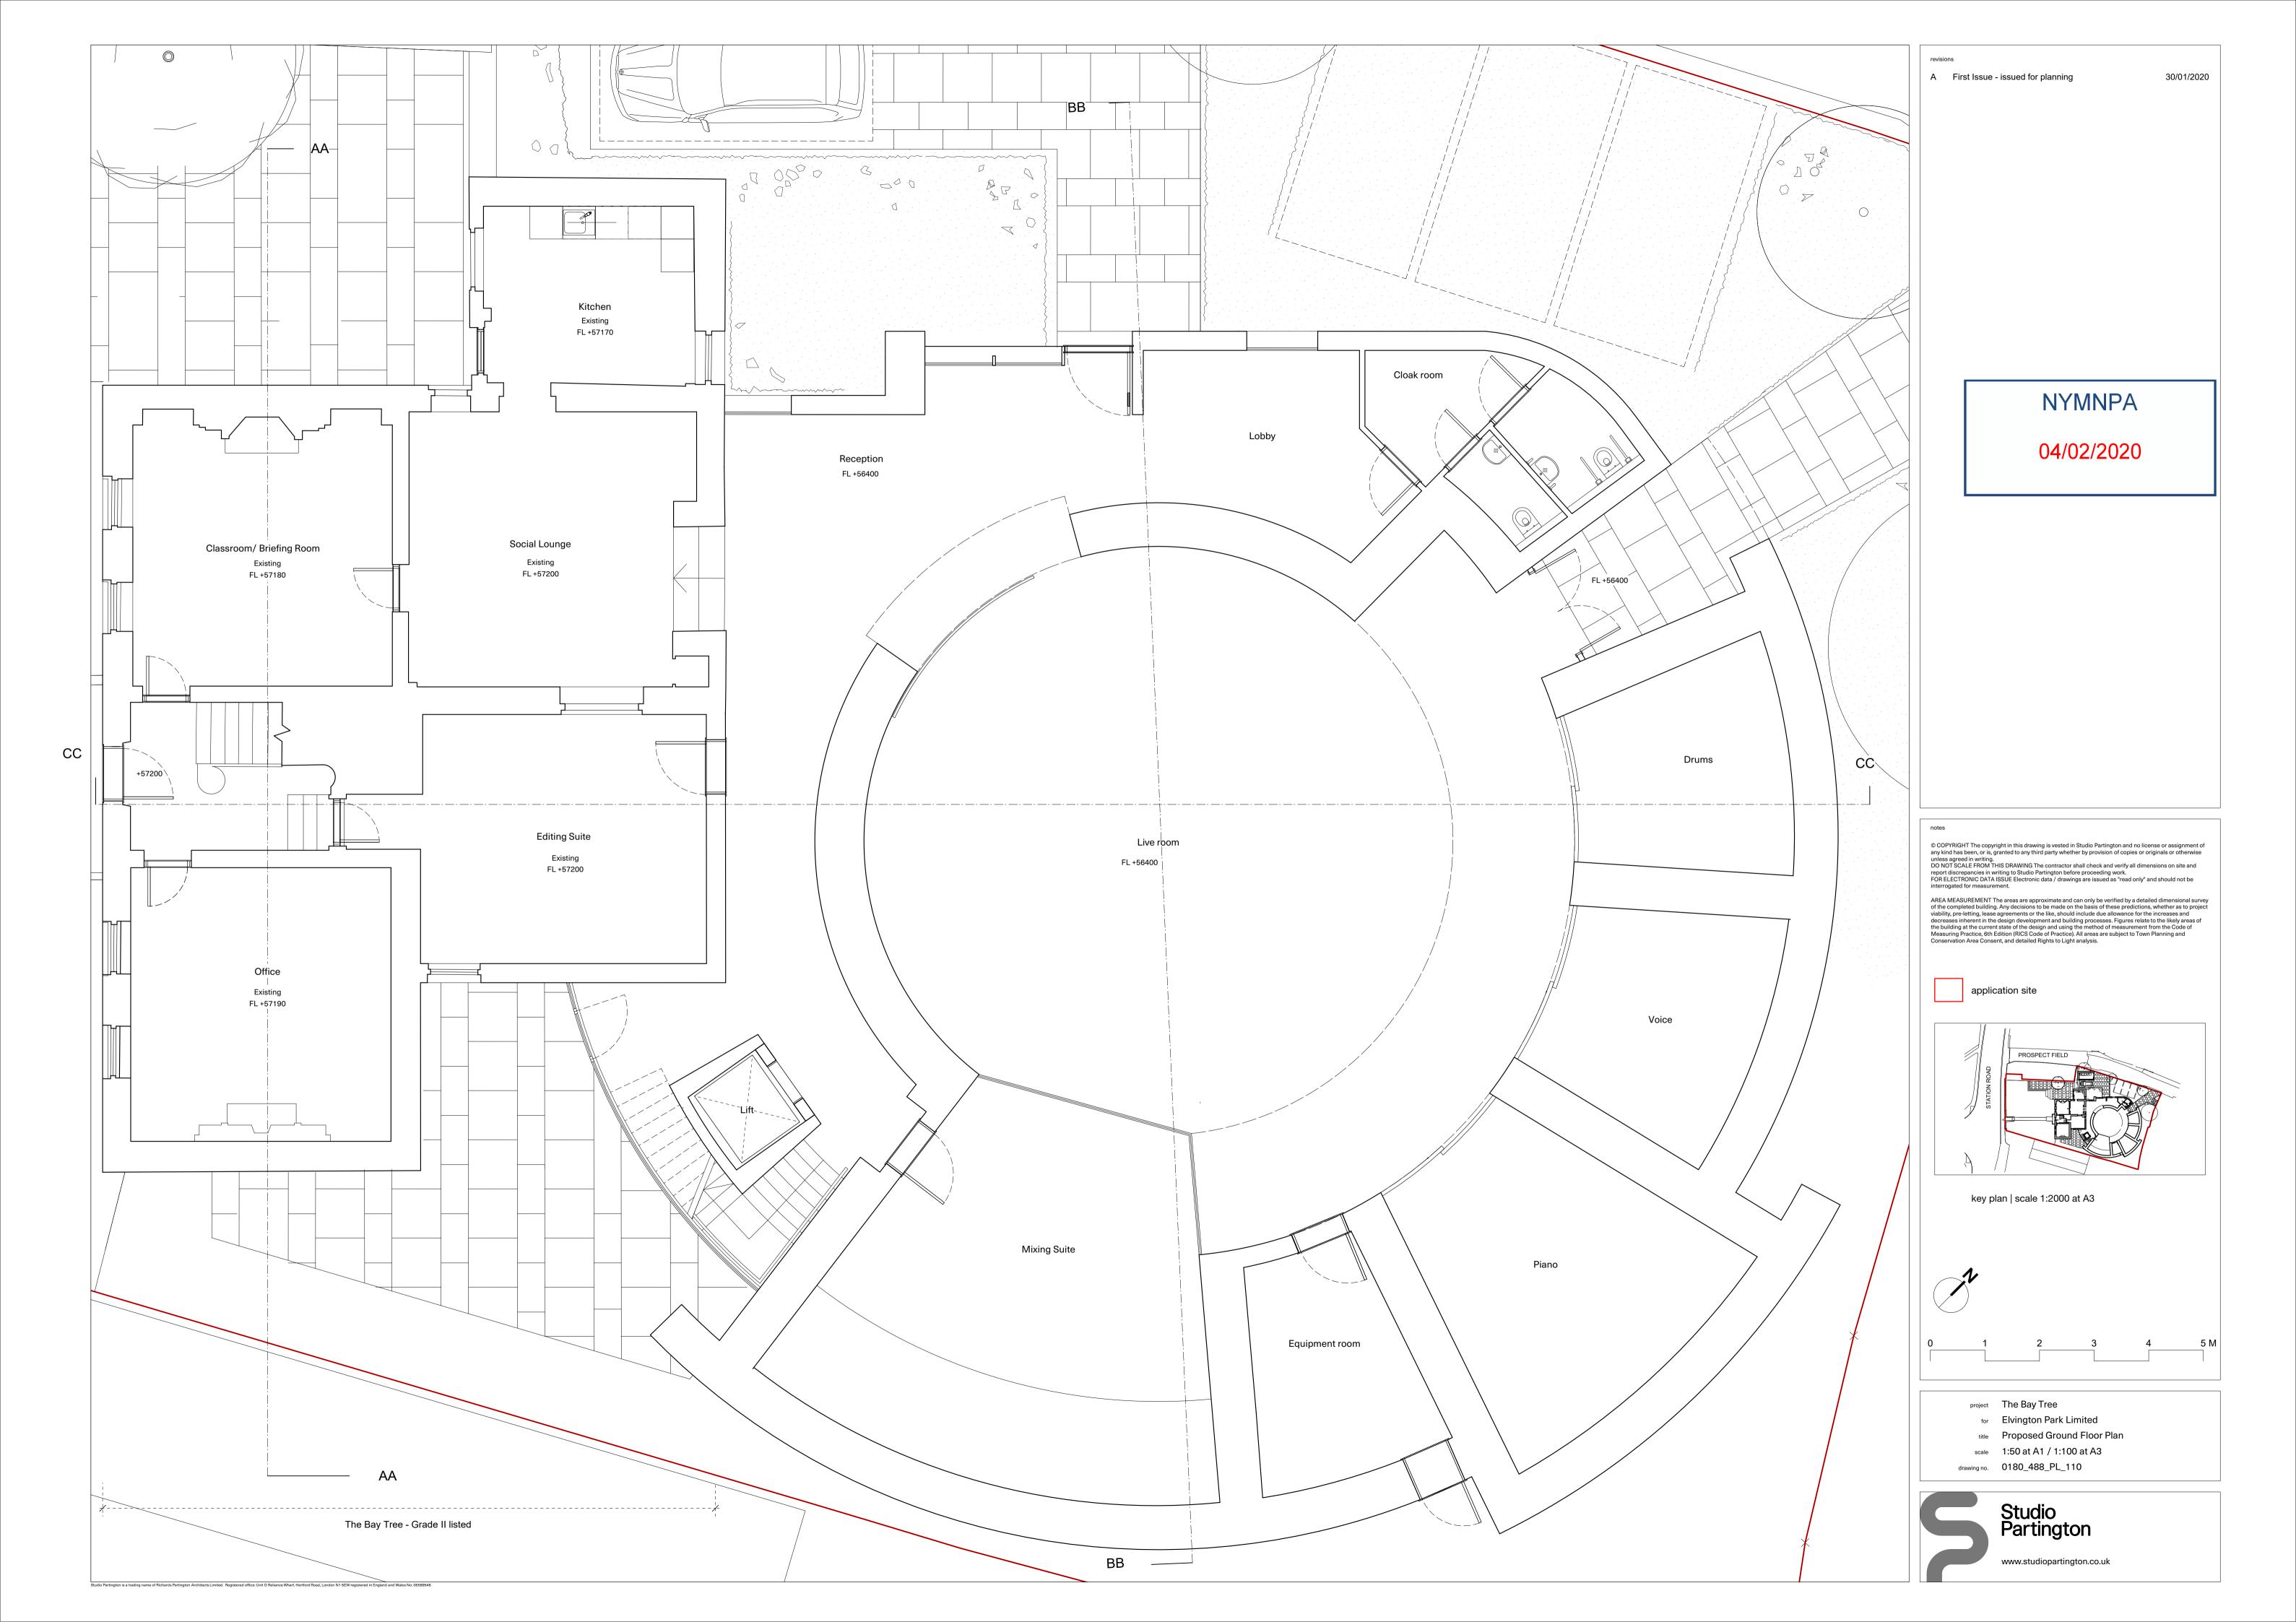

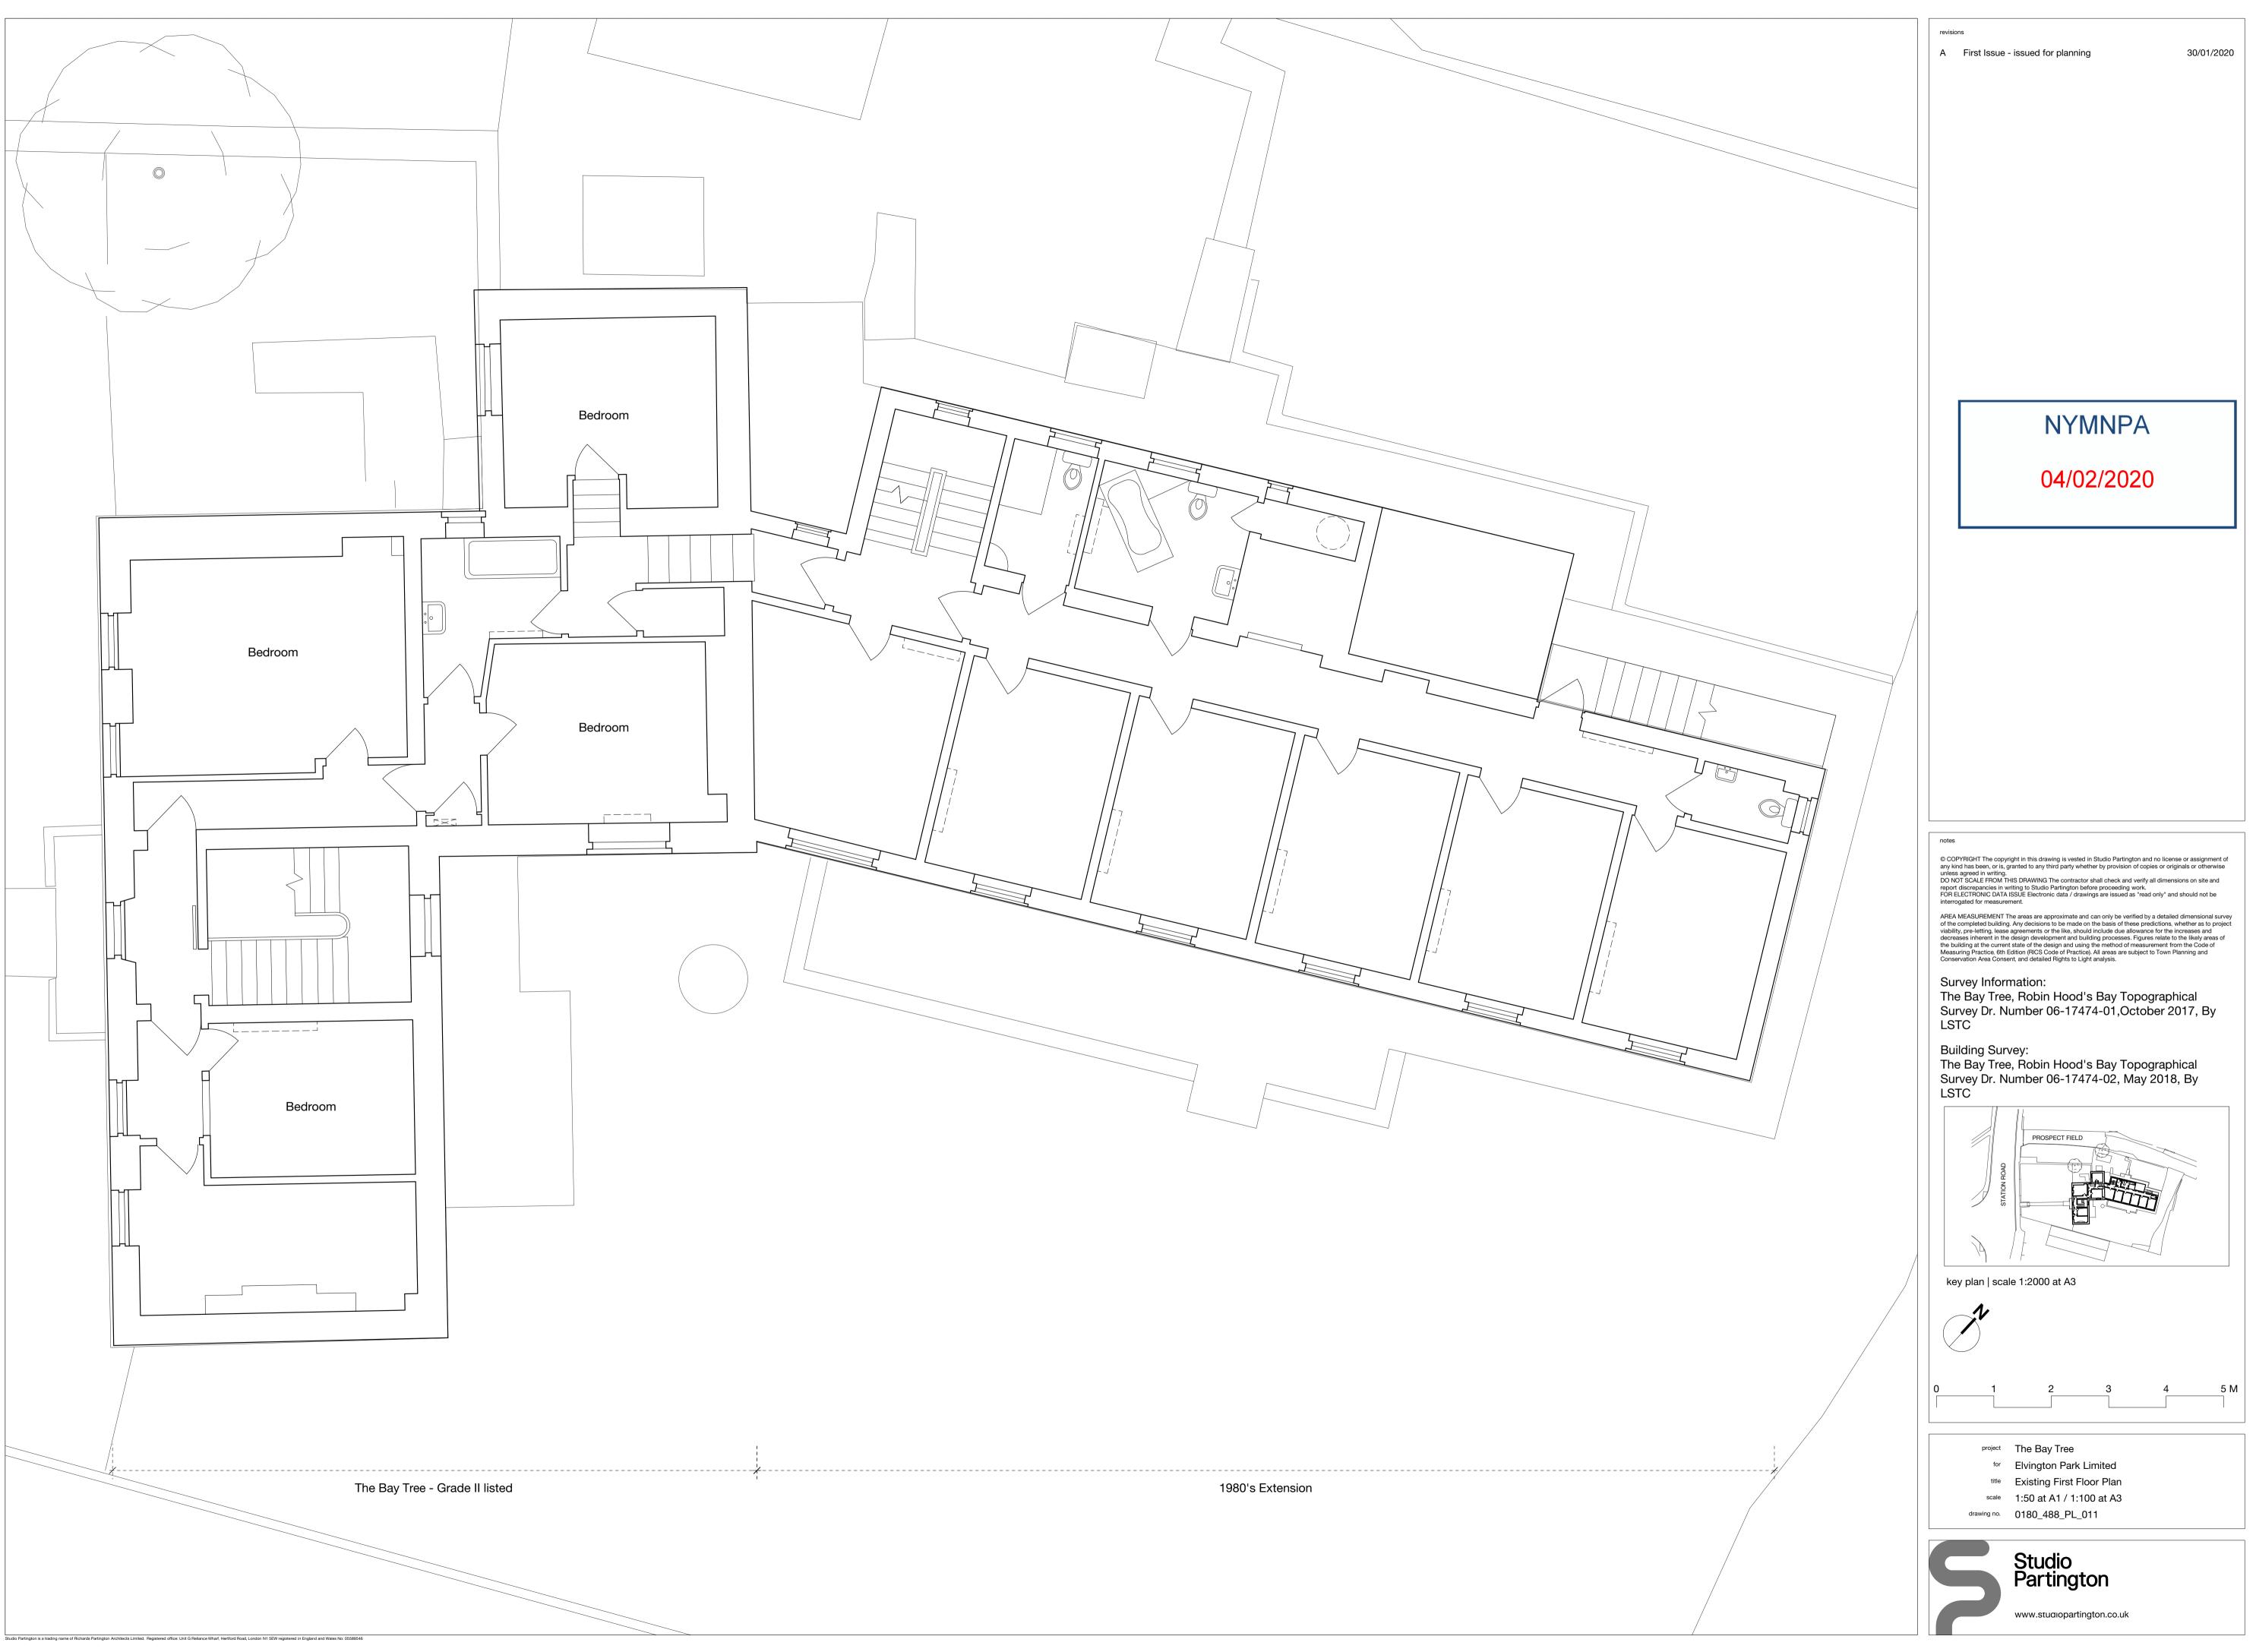


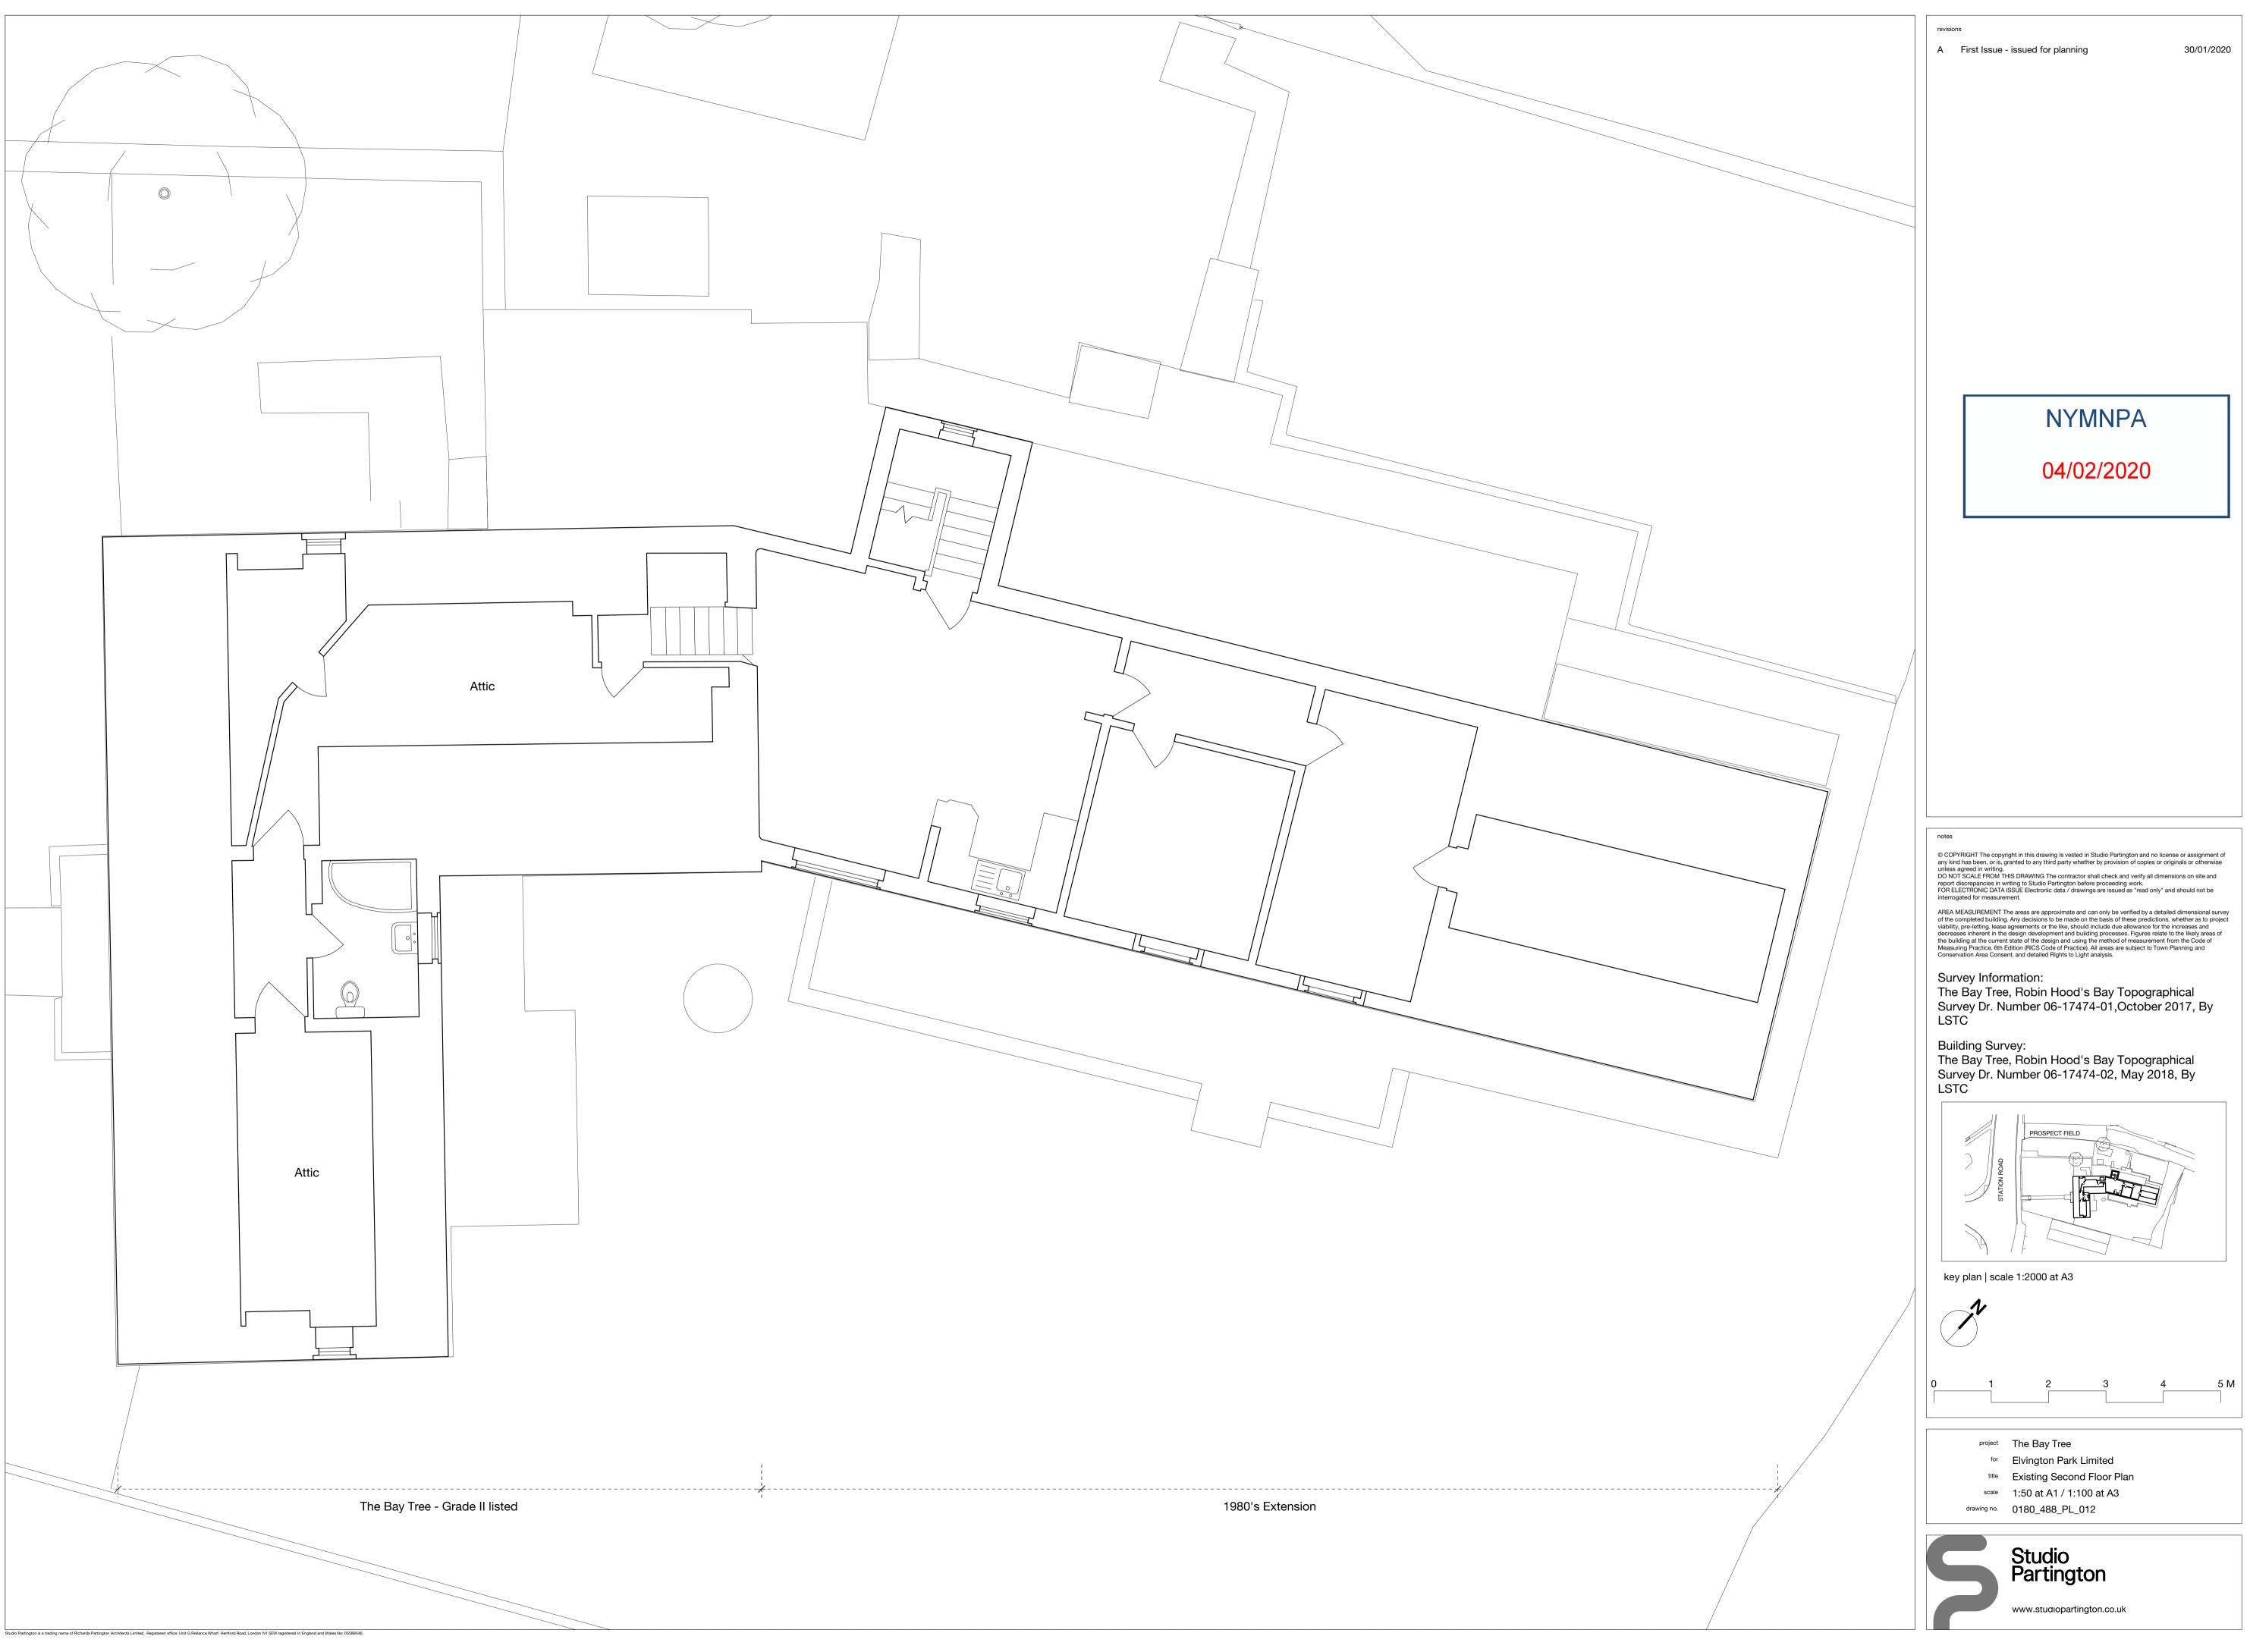



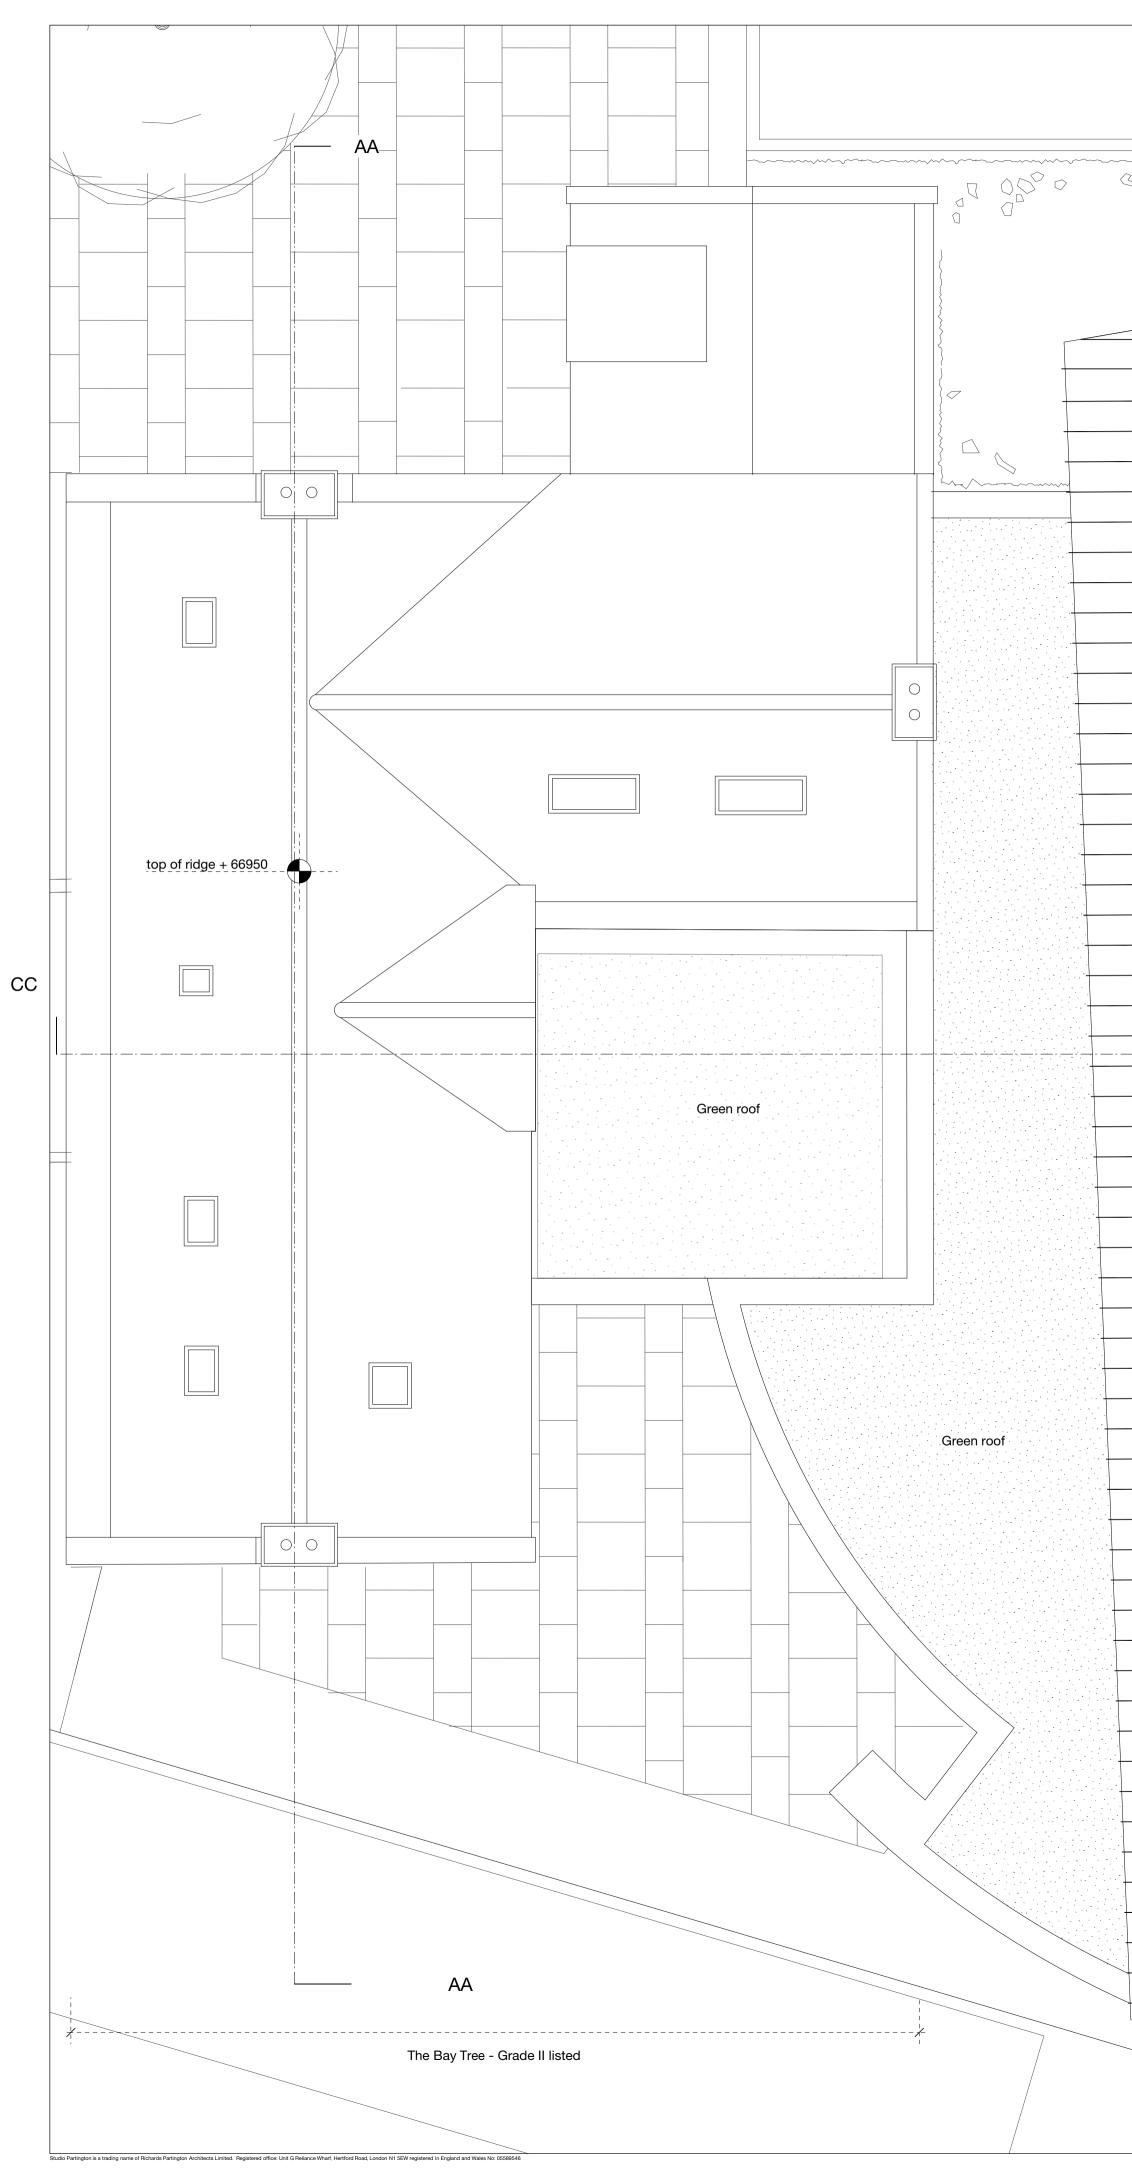


	top of ridge + 64330
Zinc roof	Green roof
BB	

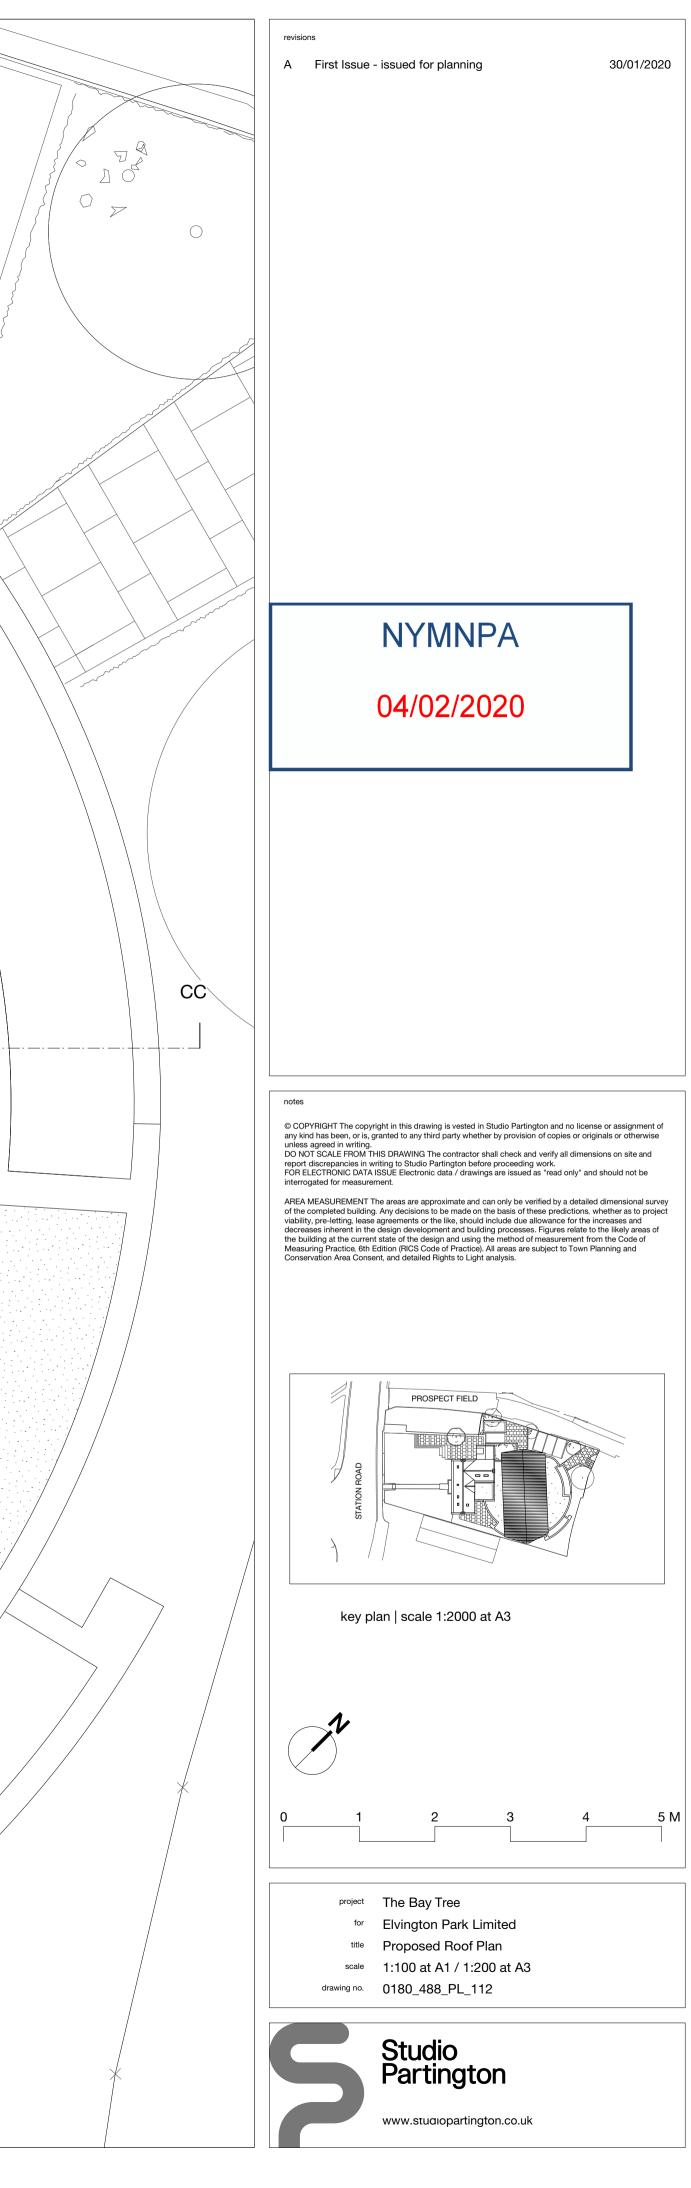



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notes         © COPYRIGHT The copyright in this drawing is vested in Studio Partington and no license or assignment of any kind has been, or is, granted to any third party whether by provision of copies or originals or otherwise unless agreed in writing.         DO NOT SCALE FROM THIS DRAWING The contractor shall check and verify all dimensions on site and report discrepancies in writing to Studio Partington before proceeding work.         FOR ELECTRONIC DATA ISSUE Electronic data / drawings are issued as "read only" and should not be interrogated for measurement.         AREA MEASUREMENT The areas are approximate and can only be verified by a detailed dimensional survey of the completed building. Any decisions to be made on the basis of these predictions, whether as to project viability, pre-letting, lease agreements or the like, should include due allowance for the increases and decreases inherent in the design development and building processes. Figures relate to the likely areas of the building at the current state of the design and using the method of measurement from the Code of Measuring Practice, 6th Edition (RICS Code of Practice). All areas are subject to Town Planning and Conservation Area Consent, and detailed Rights to Light analysis.
Survey Information: The Bay Tree, Robin Hood's Bay Topographical Survey Dr. Number 06-17474-01, October 2017, by LSTC Building Survey: The Bay Tree, Robin Hood's Bay Topographical Survey Dr. Number 06-17474-02, May 2018, by LSTC
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 0 1 2 3 4 5 M project The Bay Tree for Elvington Park Limited title Alterations: Existing Ground Floor Plan scale 1:50 at A1 / 1:100 at A3 drawing no. 0180_488_PL_014
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 0 1 2 3 4 project The Bay Tree for Elvington Park Limited title Alterations: Existing First Floor Plan scale 1:100 at A1 / 1:200 at A3 drawing no. 0180_488_PL_015	5 M
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Elevation 02

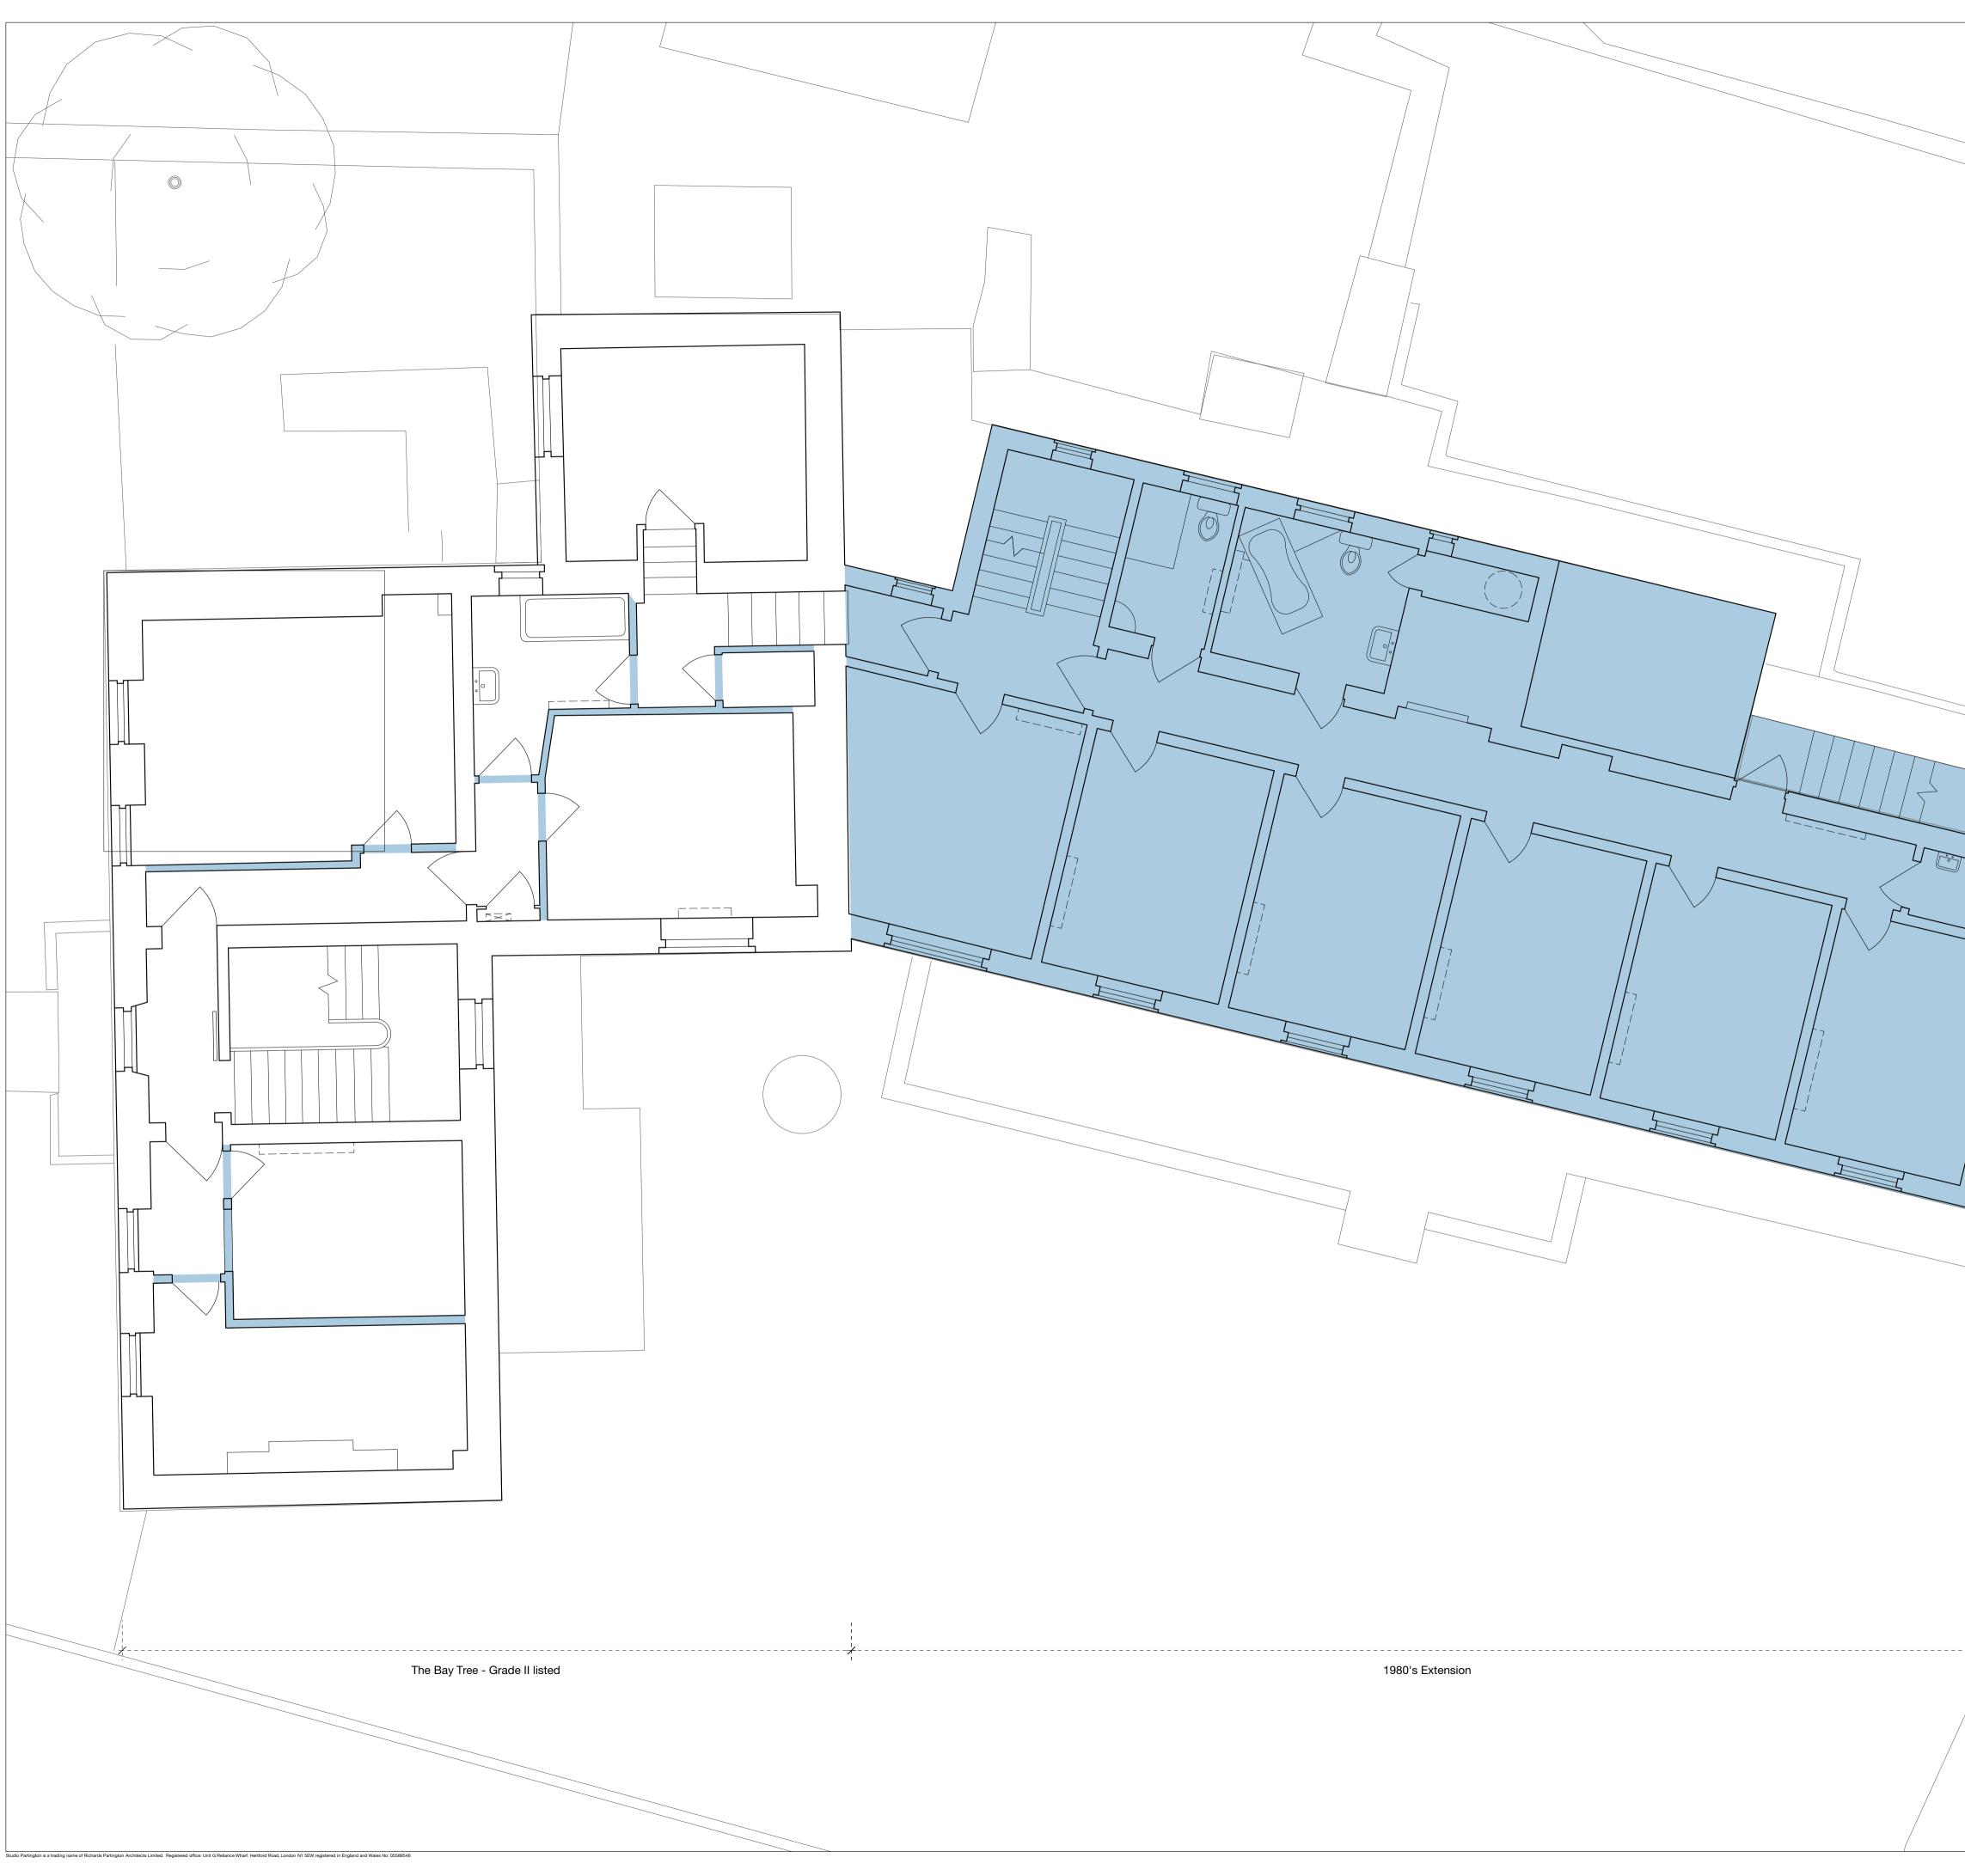
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Survey Information: The Bay Tree, Robin Hood's Bay Topographical Survey Dr. Number 06-17474-01,October 2017, By LSTC Building Survey: The Bay Tree, Robin Hood's Bay Topographical Survey Dr. Number 06-17474-02, May 2018, By LSTC
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Image: Clay tiles
2     Clay tiles       3     Existing timber frame sash windows
0 1 2 3 4 5 M
projectThe Bay TreeforElvington Park LimitedtitleExisting Elevations 01 & 02scale1:50 at A1/ 1:100 at A3drawing no.0180_488_PL_040
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Survey Information: The Bay Tree, Robin Hood's Bay Topographical Survey Dr. Number 06-17474-01,October 2017, By LSTC Building Survey: The Bay Tree, Robin Hood's Bay Topographical Survey Dr. Number 06-17474-02, May 2018, By LSTC
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Image: Construction of the second
0 1 2 3 4 5 M project The Bay Tree for Elvington Park Limited title Existing Elevations 03 & 04 scale 1:50 at A1/ 1:100 at A3 drawing no. 0180_488_PL_041
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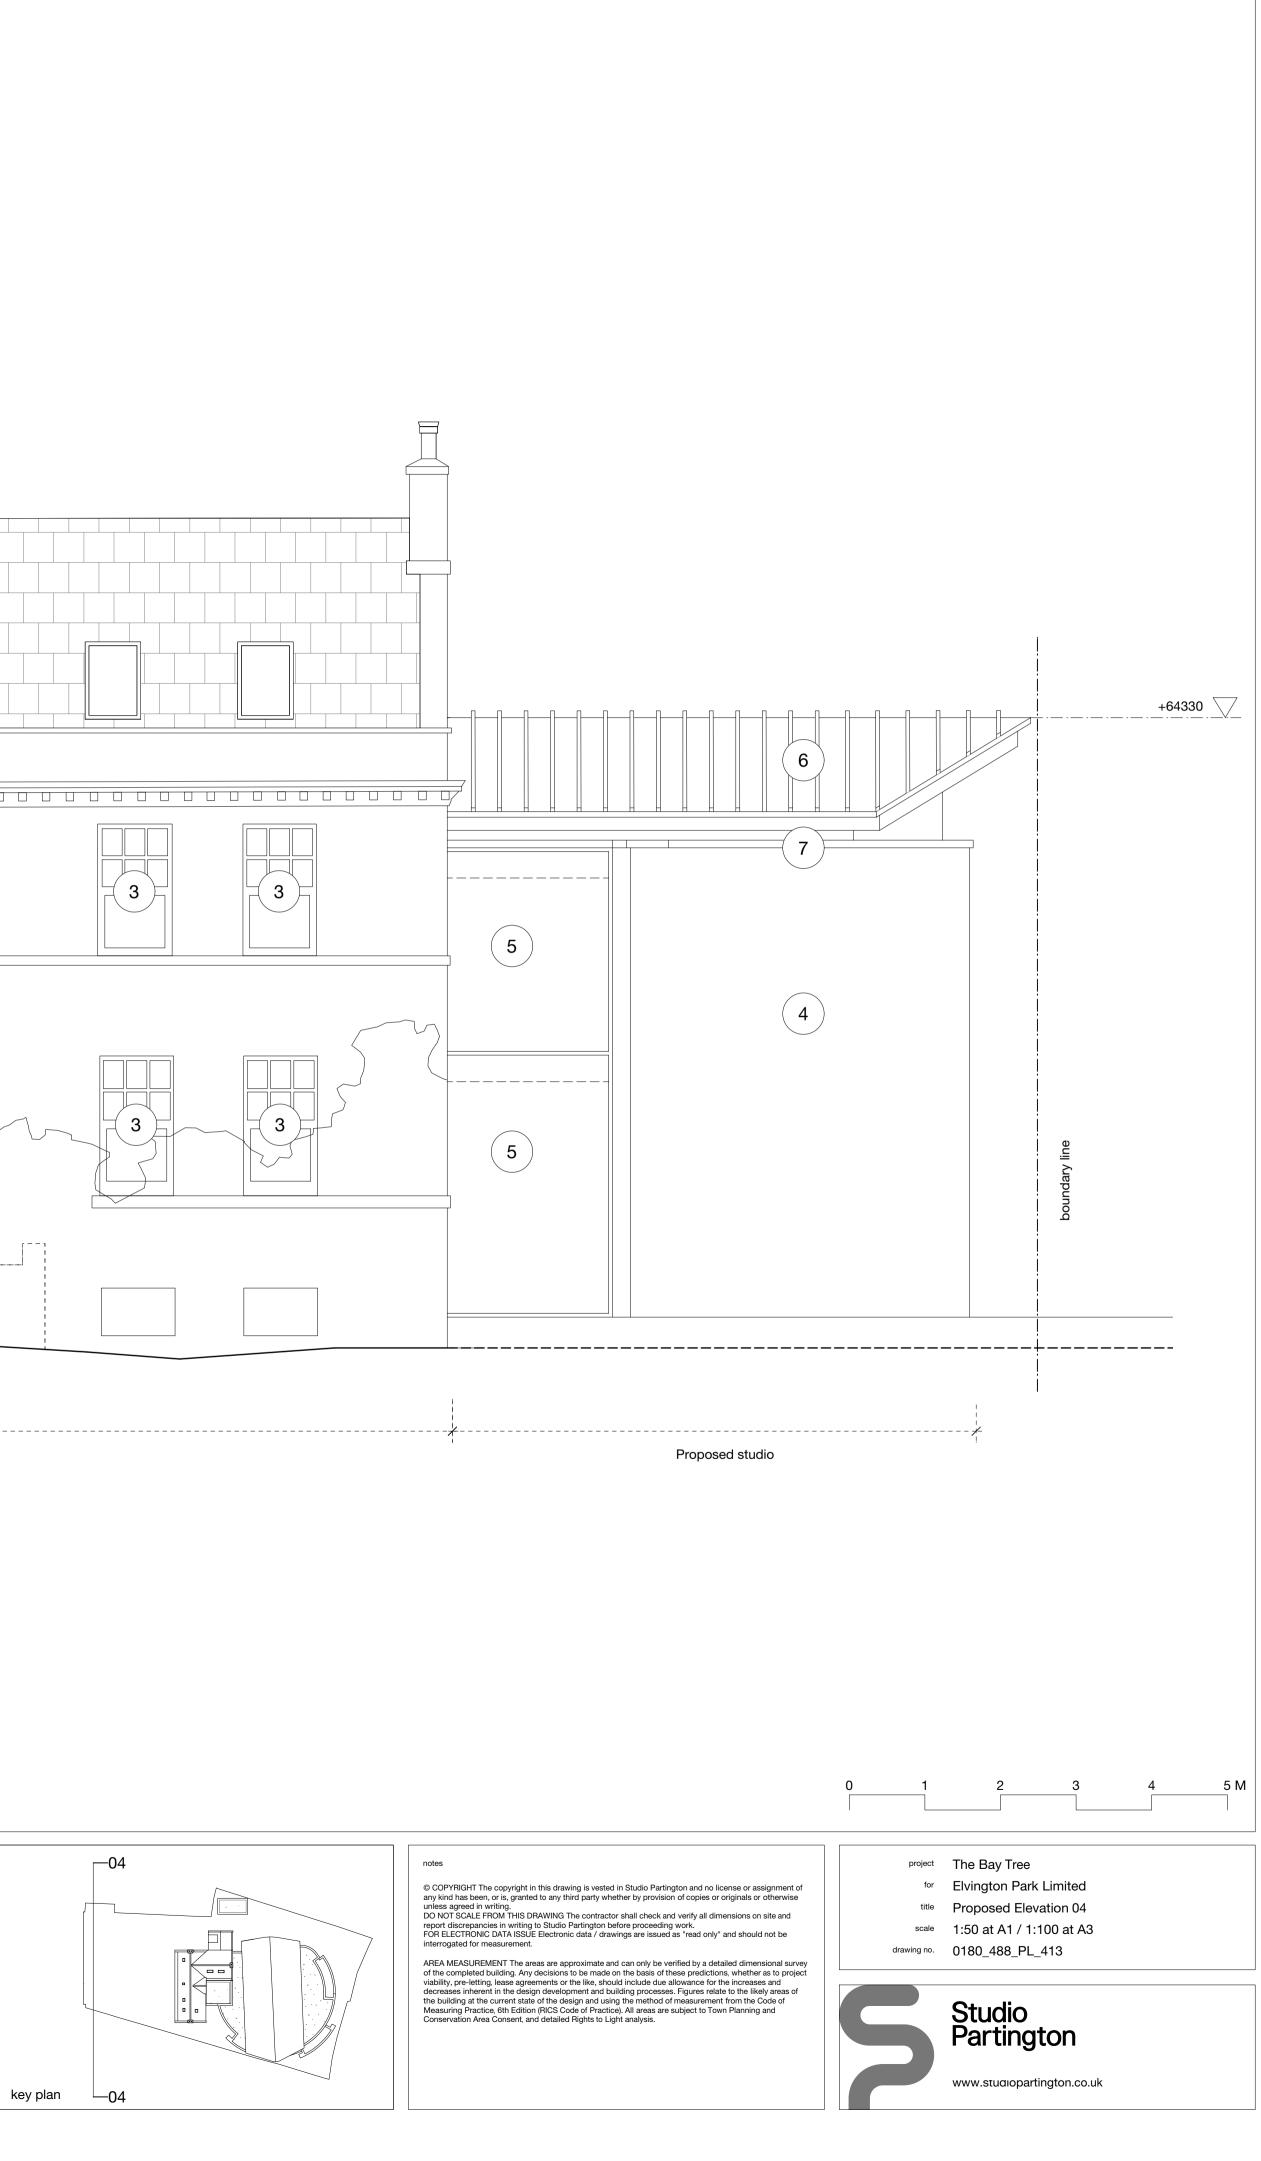



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# Elevation 04


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# Elevation 01

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 revisions
 Material Key:

 A
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 30/01/2020

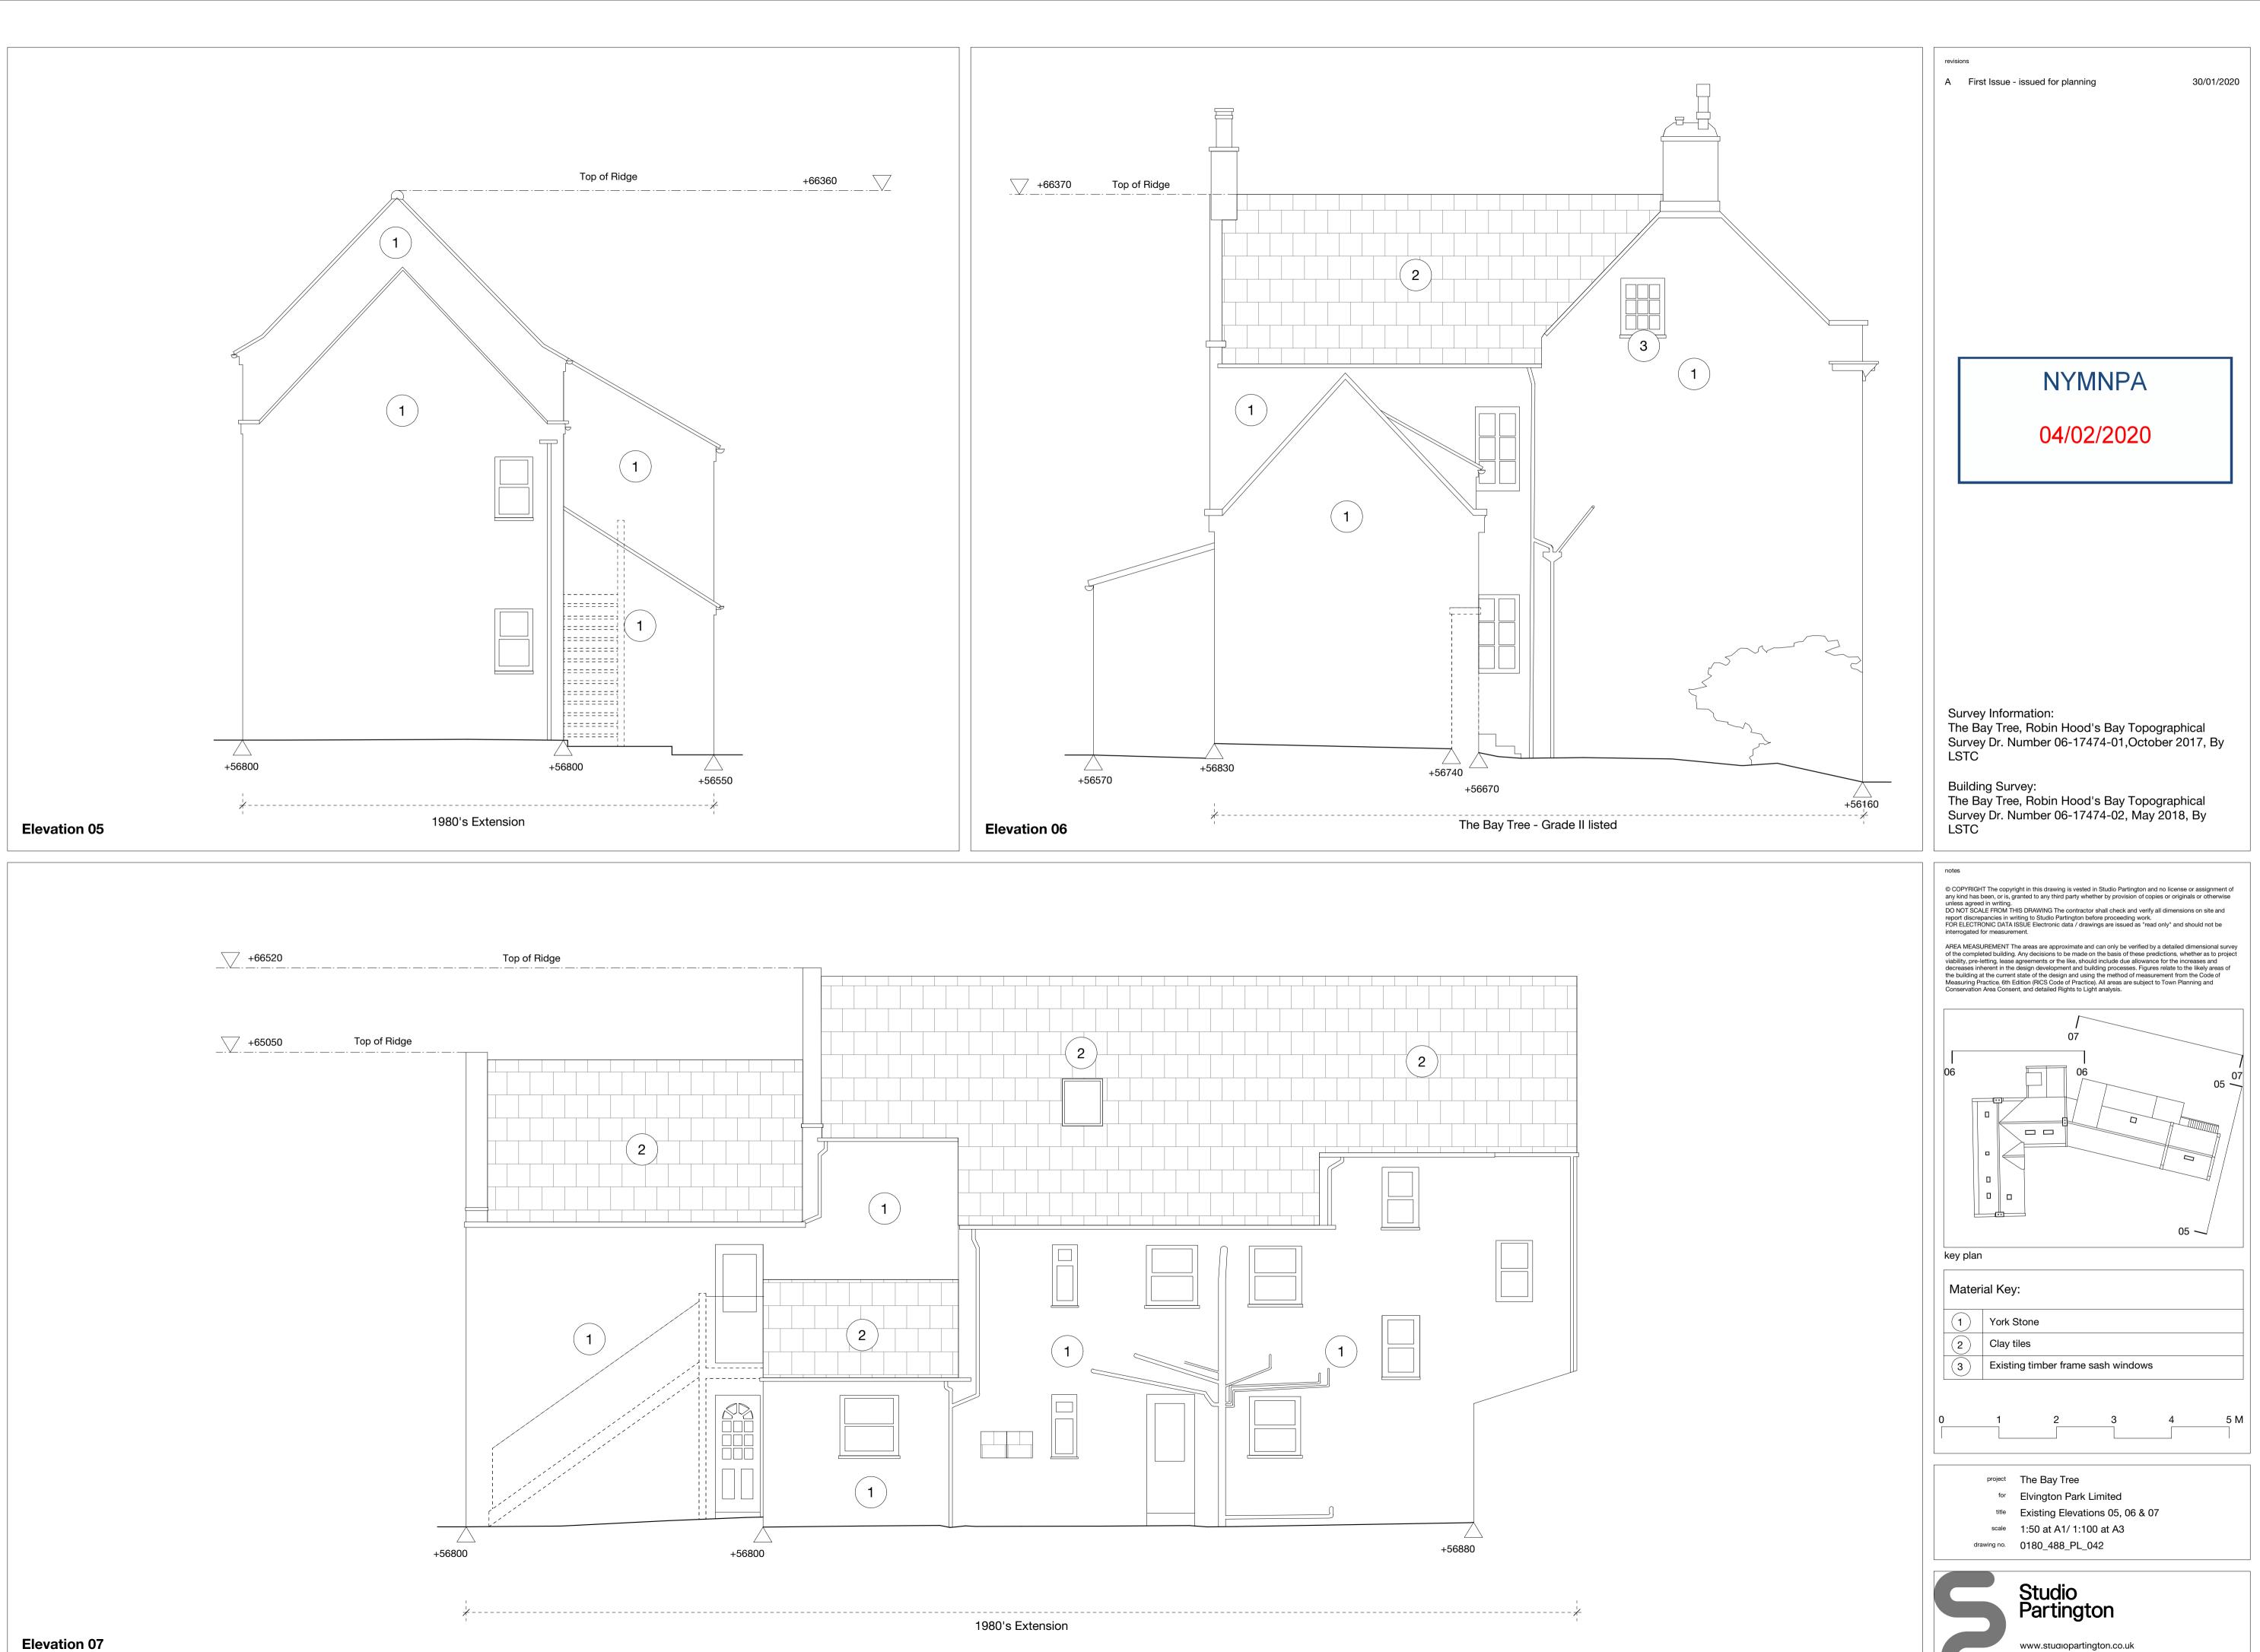 1
 York Stone

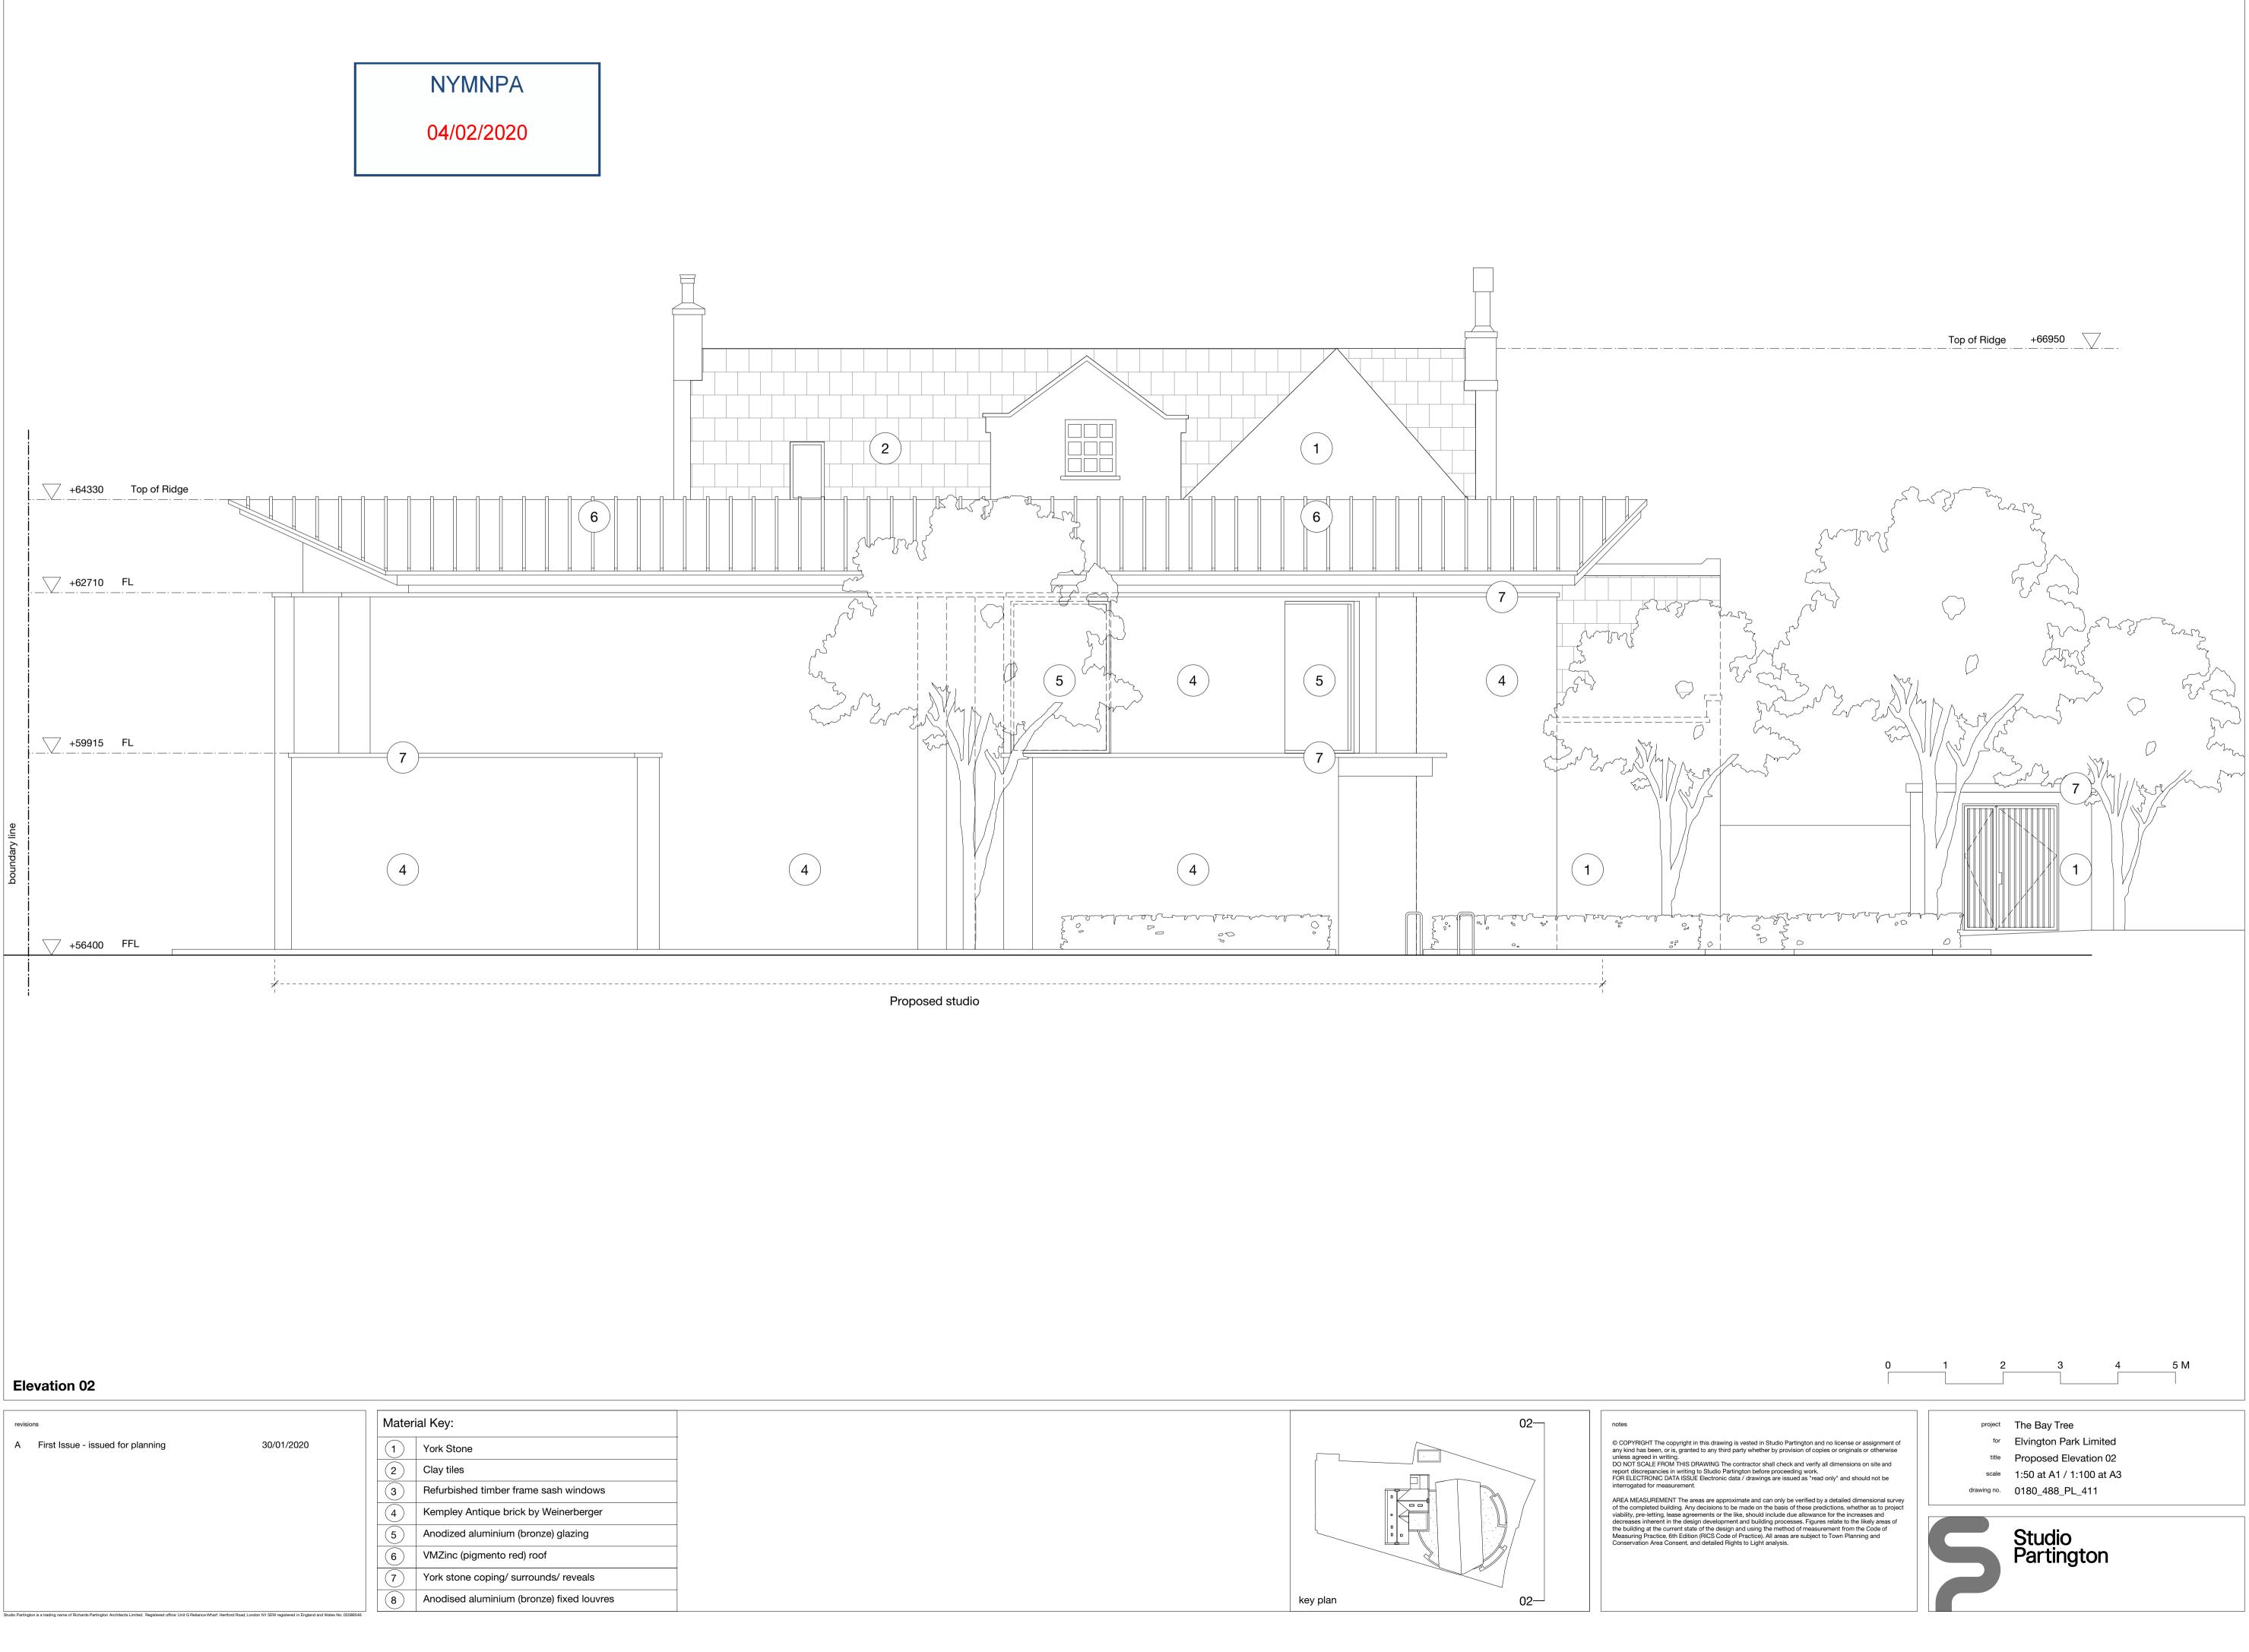 2
 Clay tiles

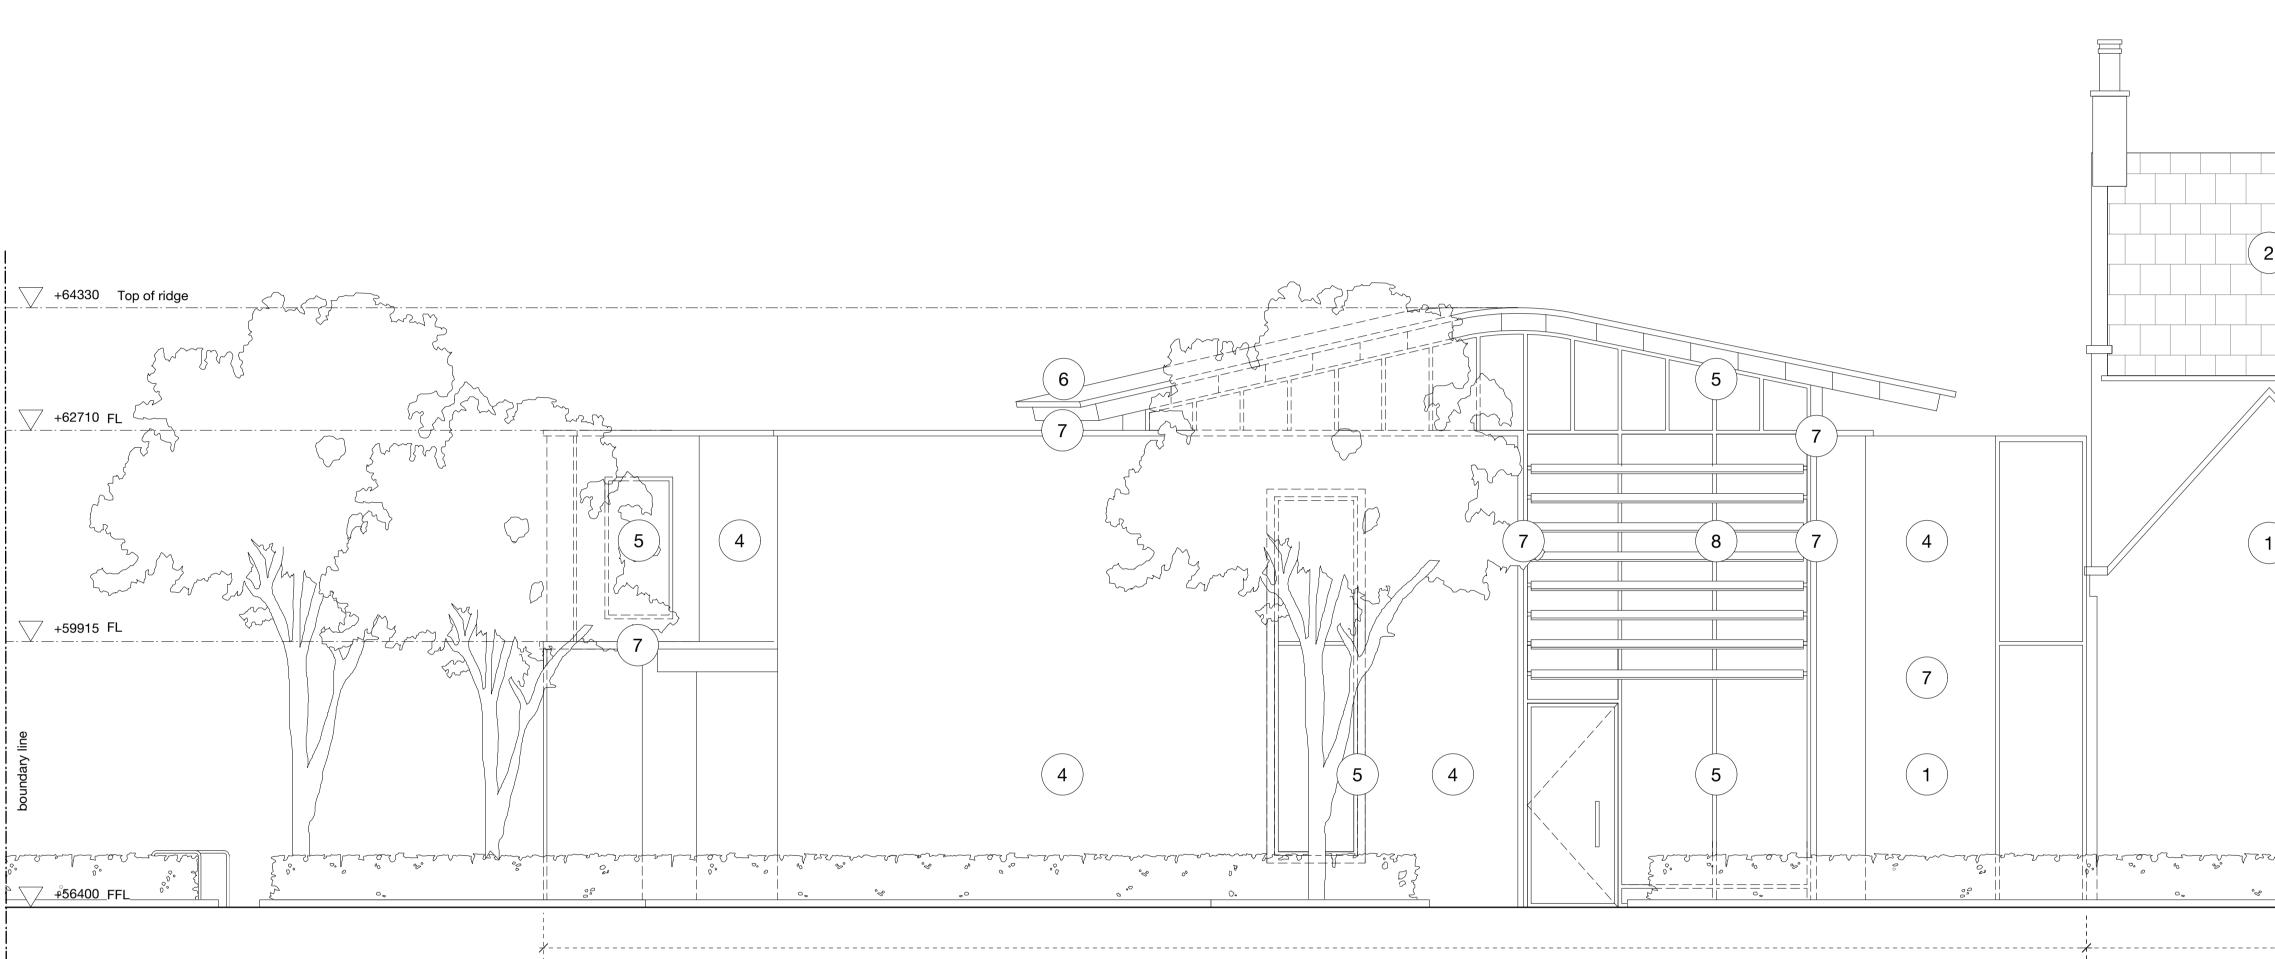 3
 Refurbished timber frame sash windows

 4
 Kempley Antique brick by Weinerberger


 5
 Anodized aluminium (bronze) glazing


 6
 VMZinc (pigmento red) roof

 7
 York stone coping/ surrounds/ reveals


 8
 Anodised aluminium (bronze) fixed louvres

Proposed studio

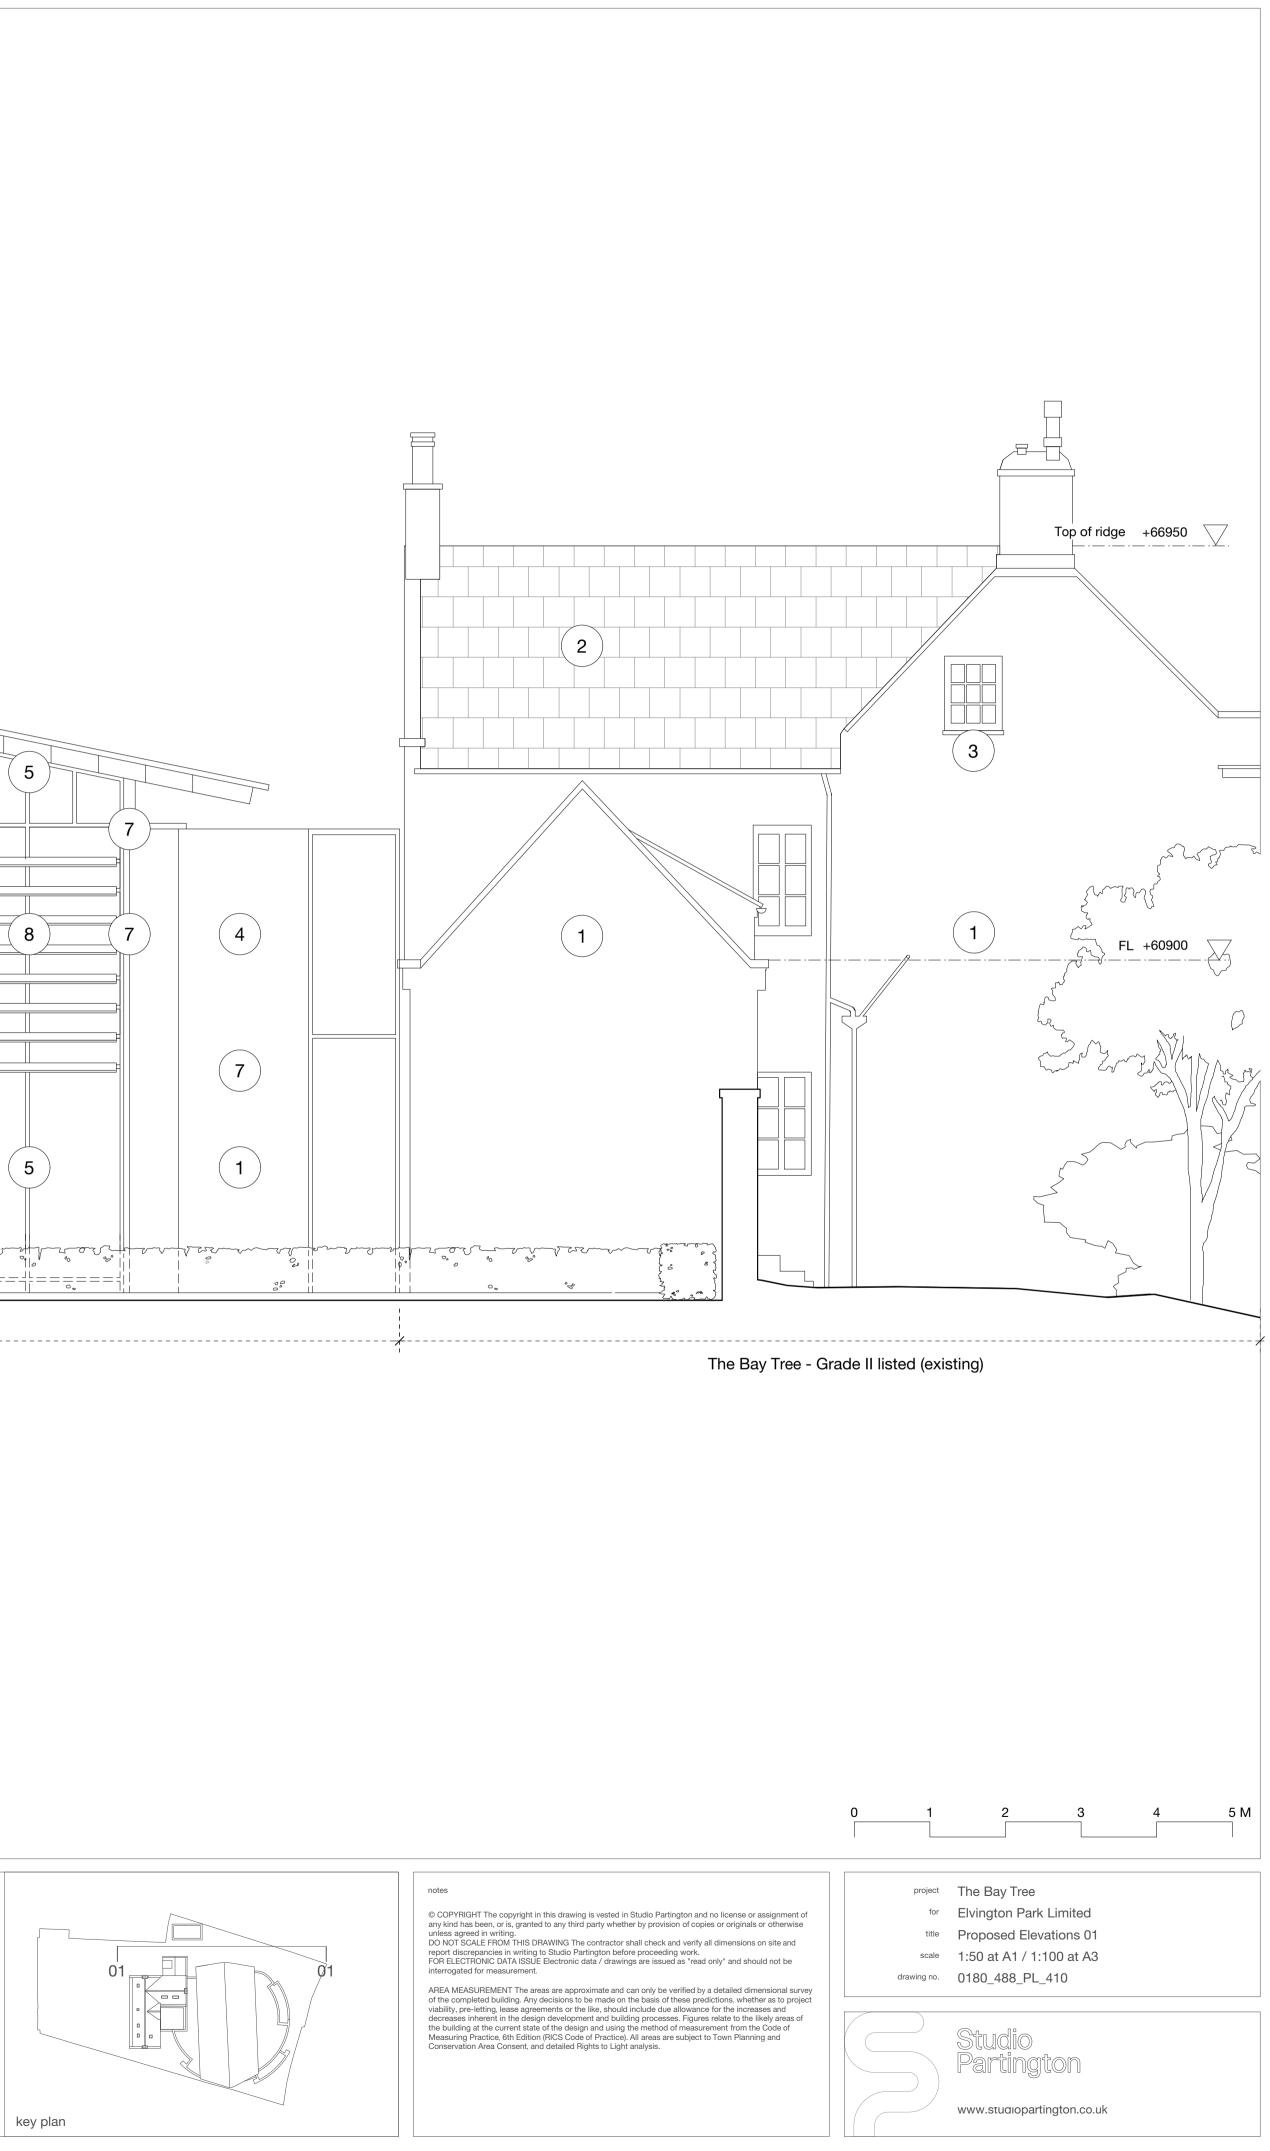

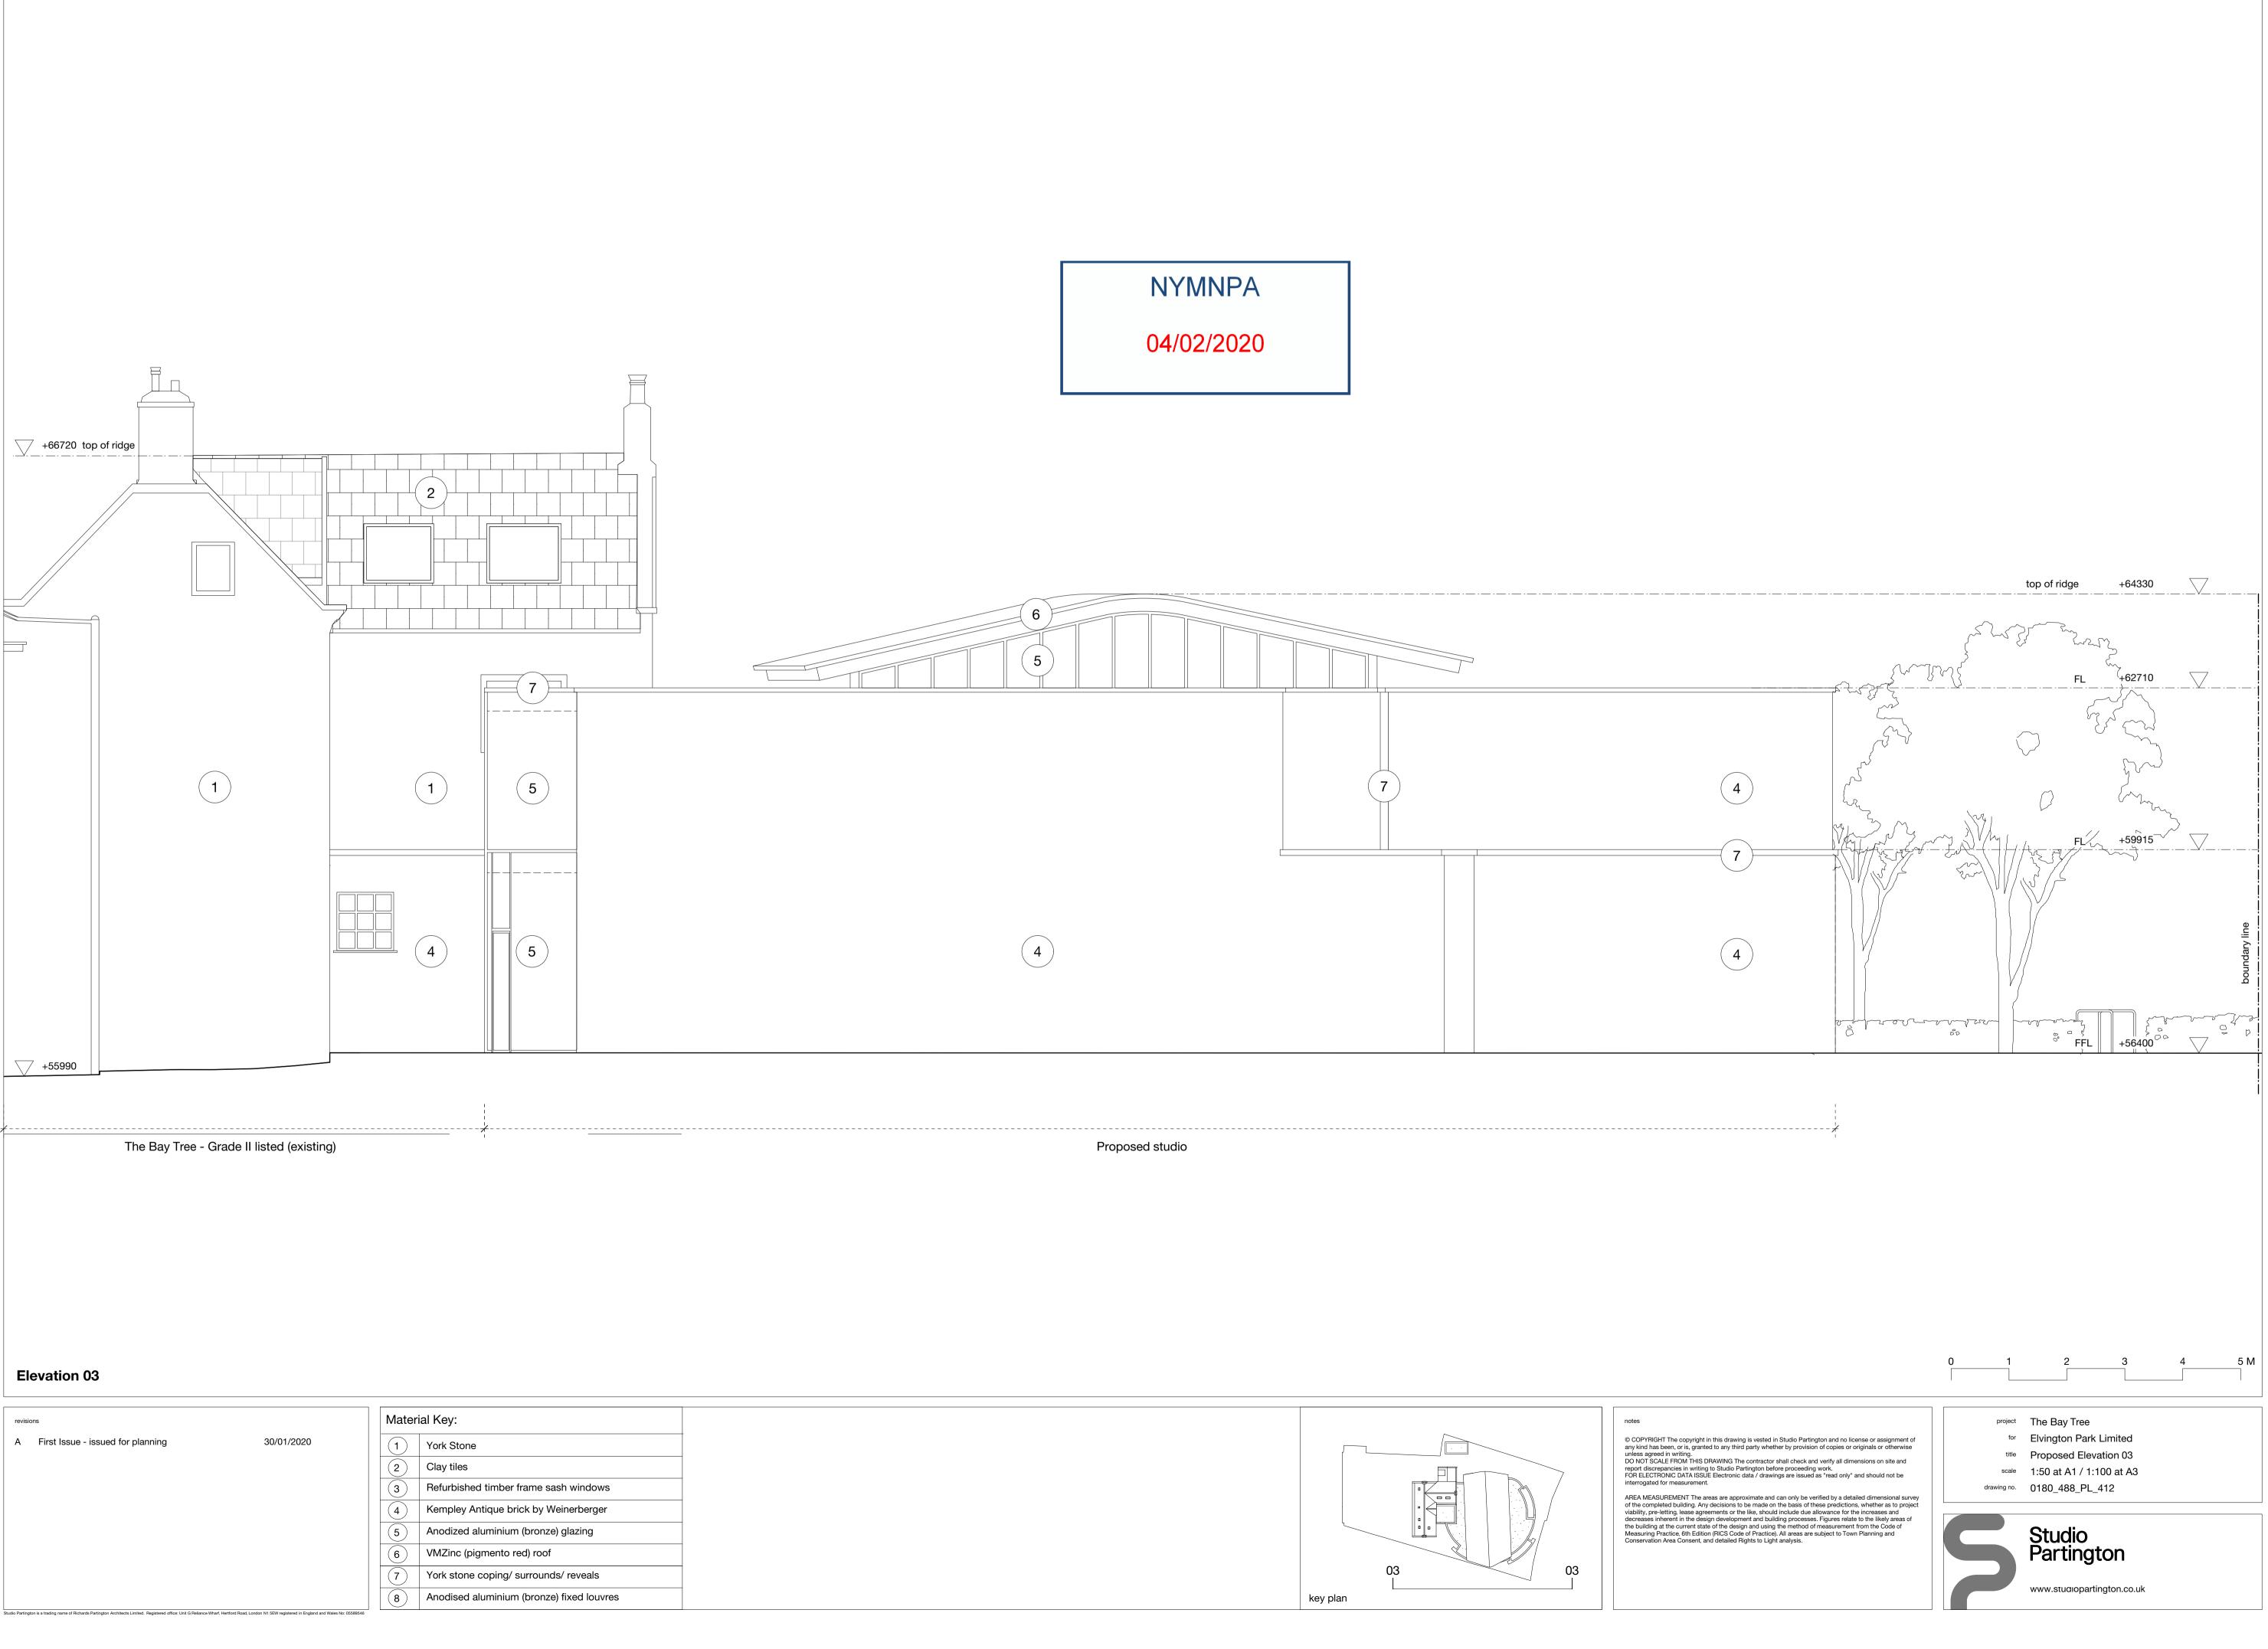



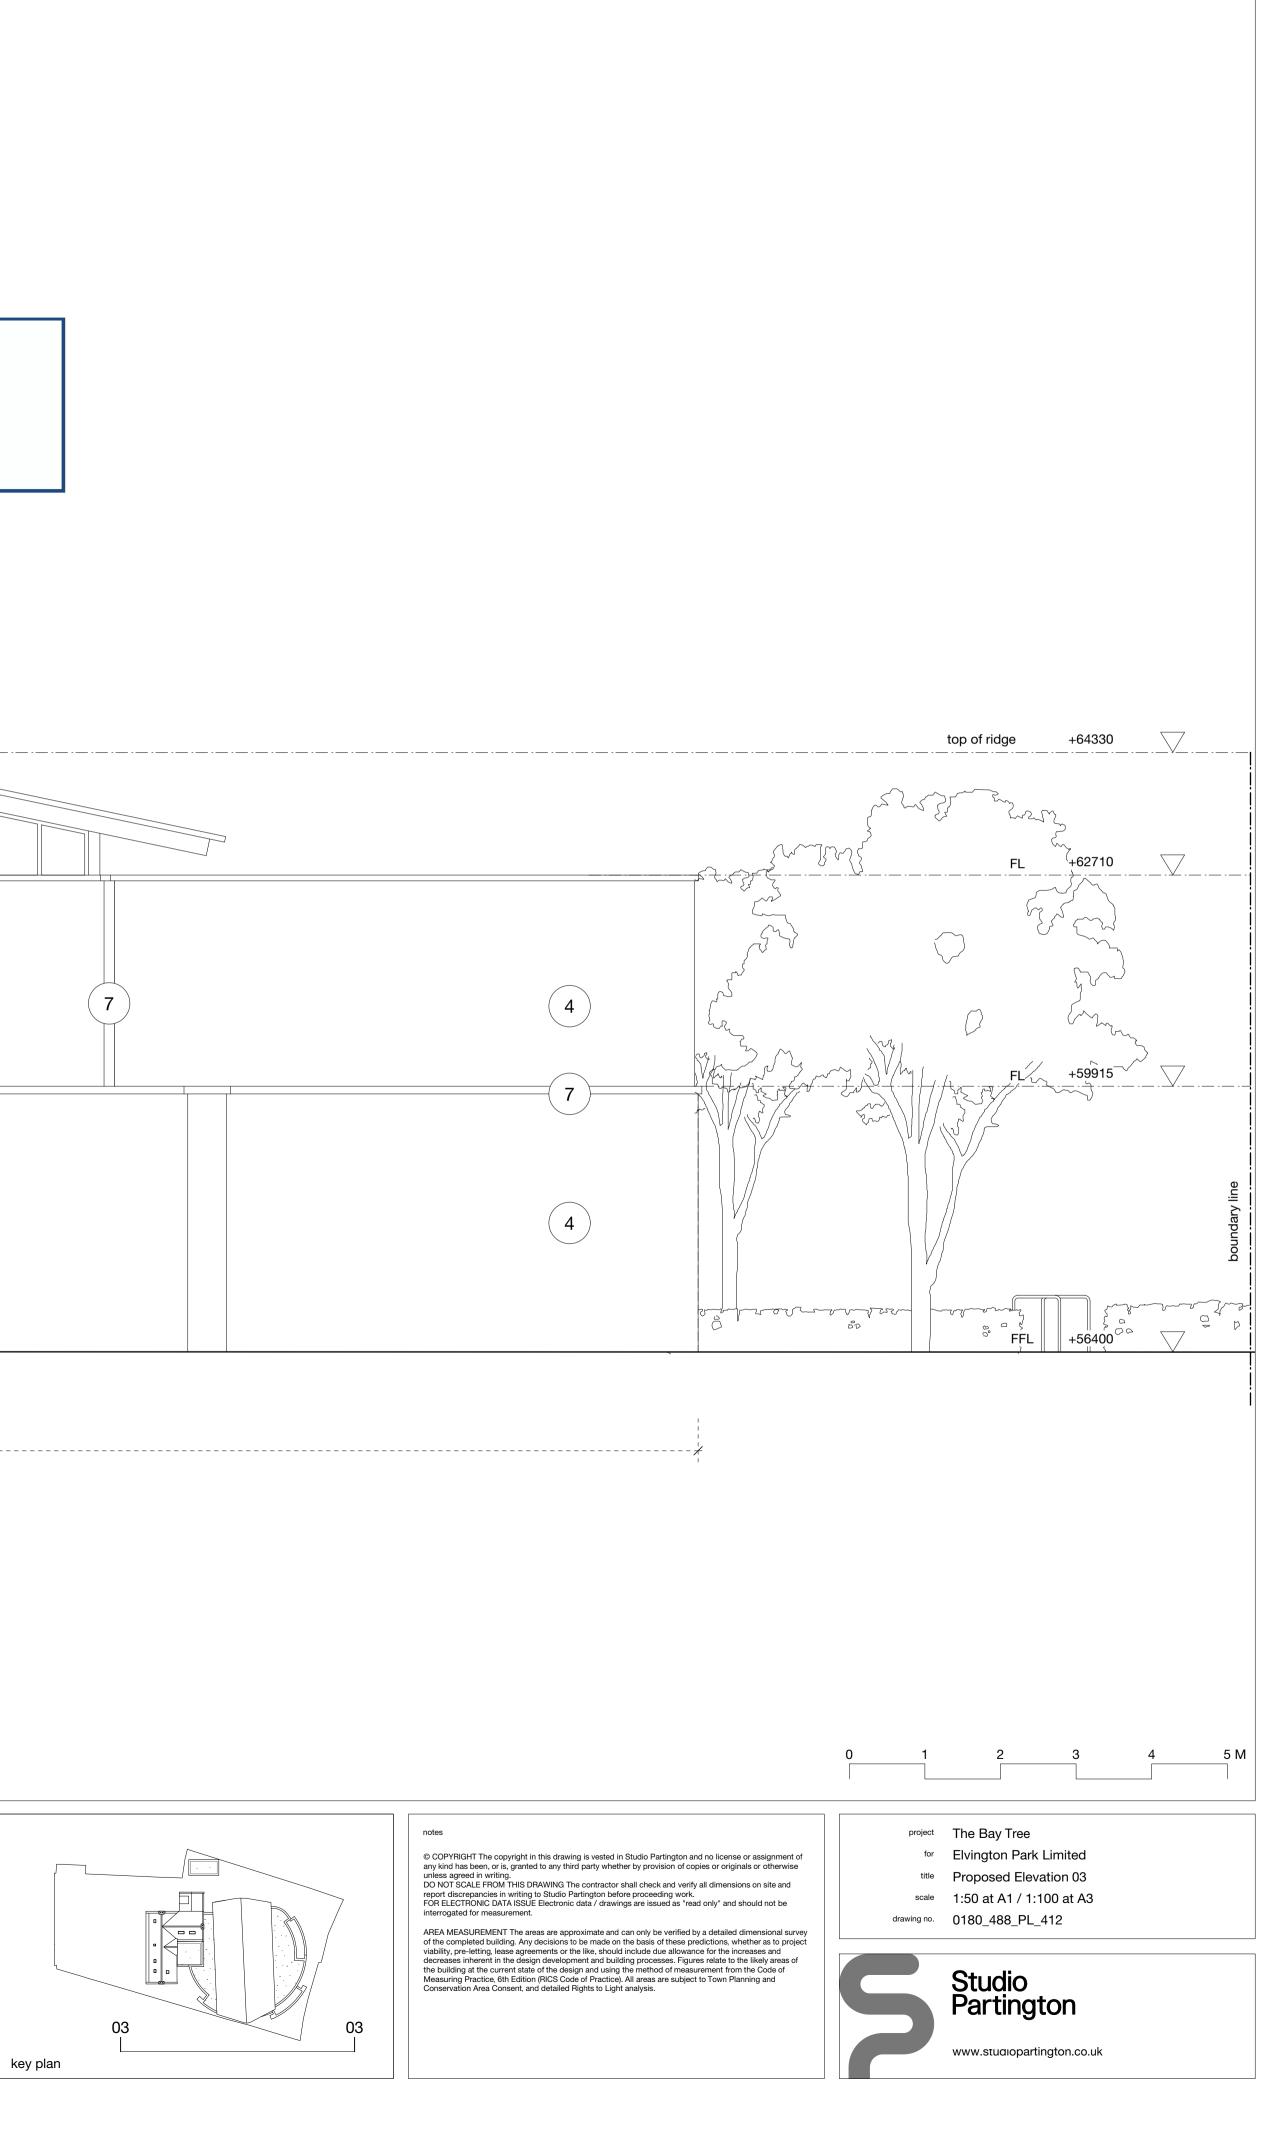







revisions	Material Key:
A First Issue - issued for planning 30/01/2020	1 York Stone
	2 Clay tiles
	3 Refurbished timber frame sash windows
	4 Kempley Antique brick by Weinerberger
	5 Anodized aluminium (bronze) glazing
	6 VMZinc (pigmento red) roof
	7 York stone coping/ surrounds/ reveals
	8 Anodised aluminium (bronze) fixed louvres
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