07/12/2022

SITE LOCATION PLAN AREA 2 HA

SCALE: 1:1250 on A4

CENTRE COORDINATES: 491219 , 508471



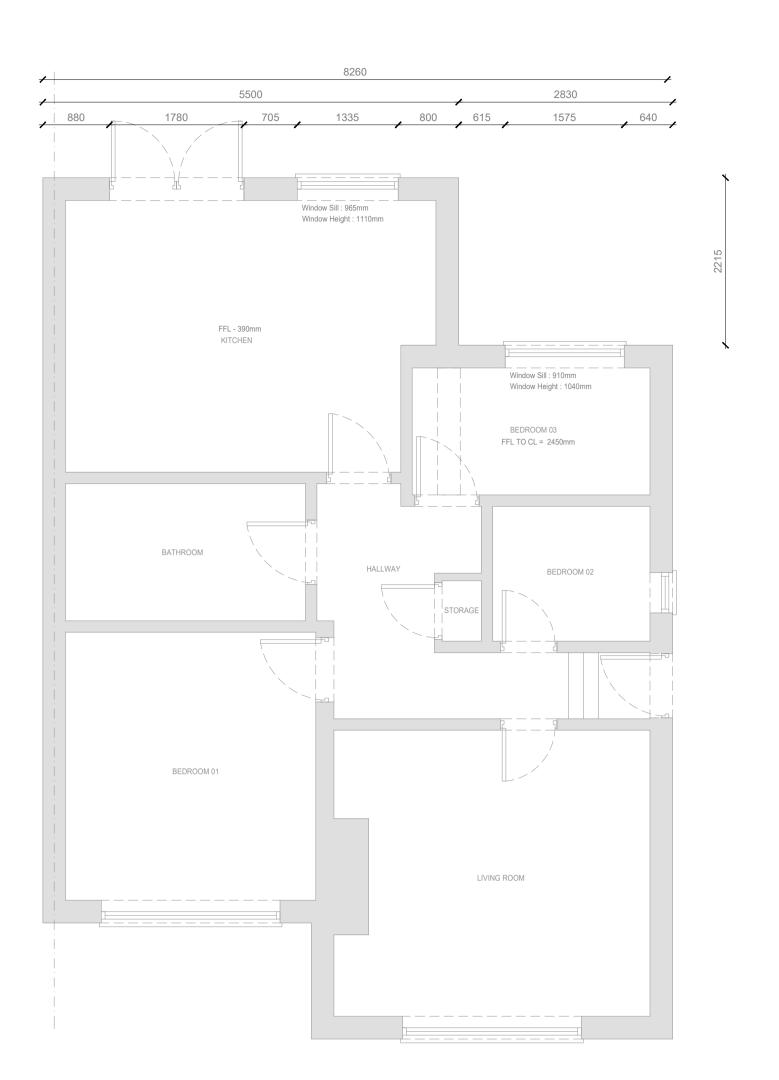


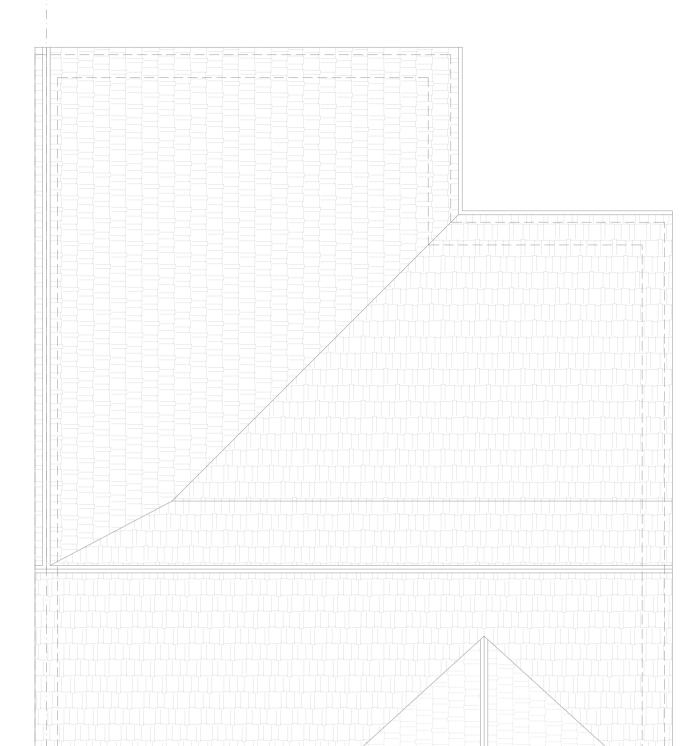
BLOCK/SITE PLAN AREA 90m x 90m SCALE: 1:500 on A4

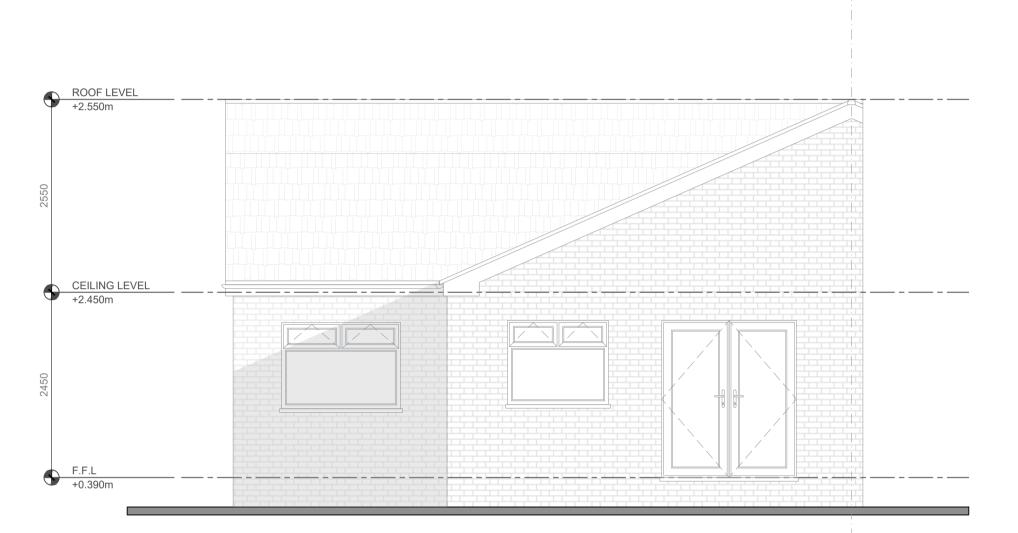
491215 , 508433












EXISTING GROUND FLOOR PLAN SCALE 1:50

EXISTING ROOF PLAN SCALE 1:50

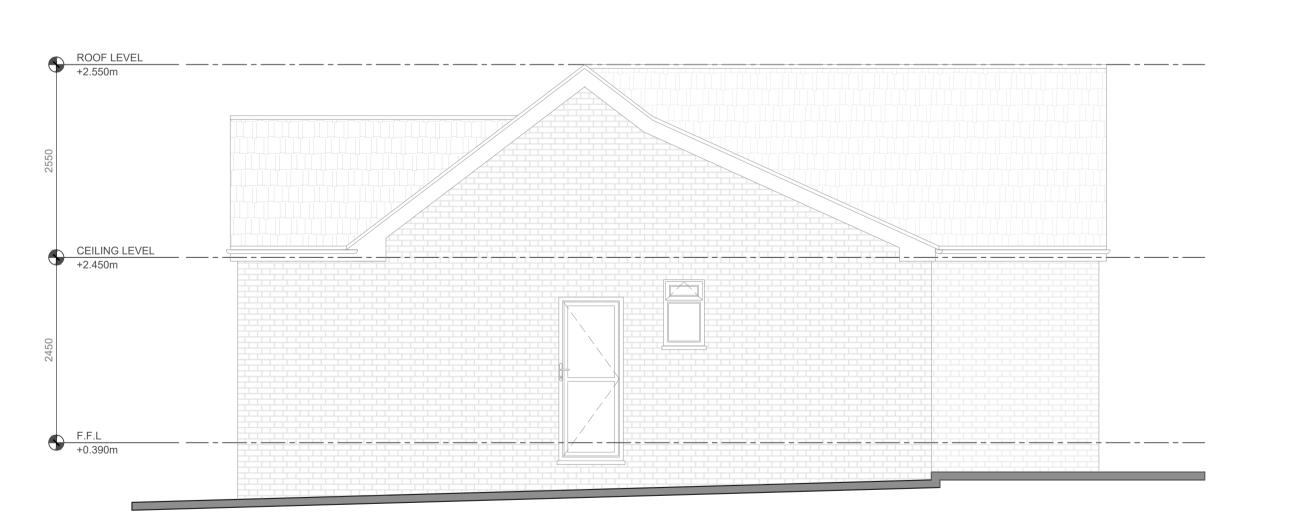EXISTING REAR ELEVATION SCALE 1:50



EXISTING LEFT SIDE ELEVATION SCALE 1:50

LEGEND

NYMNPA

07/12/2022

Full Fill Cavity Wall To achieve minimum U Value of 0.18 W/m²K

New cavity wall to comprise of 103mm suitable facing brick. Full fill cavity with 175mm Rockwool Cavity insulation as manufacturer's details. Inner leaf to be 100mm medium block, 0.45 W/m²K. Internal finish to be 12.5mm plasterboard on dabs. Walls to be built with 1:1:6 cement mortar.

FULL FILL CAVITY WALL

To achieve minimum U Value of 0.18 W/m²K 20mm two coat sand/cement render to comply to BS EN 13914-1 with waterproof additive on 100mm standard block, 0.45 W/m²K. Fully fill the cavity with 175mm Rockwool cavity insulation as manufacturer's spec. Inner leaf to be 100mm standard block, 0.45 W/m²K. Internal finish to be 12.5mm plasterboard on dabs. Walls to be built with 1:1:6 cement mortar.

INTERNAL STUD PARTITIONS

100mm x 50mm softwood treated timbers studs at 400mm ctrs with 50 x 100mm head and sole plates and solid intermediate horizontal noggins at 1/3 height or 450mm. Provide min 10kg/m³ density acoustic soundproof quilt tightly packed (eg. 100mm Rockwool or Isowool mineral fibre sound insulation) in all voids the full depth of the stud. Partitions built off doubled up joists where partitions run parallel or provide noggins where at right angles, or built off DPC on thickened concrete slab if solid ground floor. Walls faced throughout with 12.5mm plaster board with skim plaster finish. Taped and jointed complete with beads and stops.

INTERNAL MASONRY PARTITIONS (BLOCKWORK) Construct non load bearing internal masonry partitions using dense concrete blocks built off thickened floor slab and tied at 225mm centres with proprietary steel profiles or block bonded to all internal and external walls. Walls faced throughout with 12.5mm plasterboard on dabs with

skim plaster finish or 13mm lightweight plaster.

New steel beams to be encased in 12.5mm Gyproc FireLine board with staggered joints, Gypro FireCase or painted in Nullifire S or similar intumescent paint to provide 1/2 hour fire resistance as agreed with Building Control. All fire protection to be installed as detailed by specialist manufacturer. Engineer to confirm all steel and structural work.

EXTERNAL BRICKWORK WALL 100mm brick external walls with 100 X 400mm piers at maximum 3.0m ctrs.

REVISIONS

REV	DATE	CHANGES
1	11/10/22	Initial Draft

JOB INFORMATION

ADDRESS: 20 RIGG VIEW, STAINSACRE, WHITBY, YO22 4NR

CLIENT NAME: TRACY SANDERSON.

PROJECT: SINGLE STOREY REAR EXTENSION.

DRAWINGS:

Existing Drawings - Page 01

DATE:

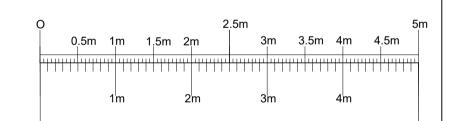
11/10/22

SCALE:

1:50:100 @A1

DRAWN BY:

TB



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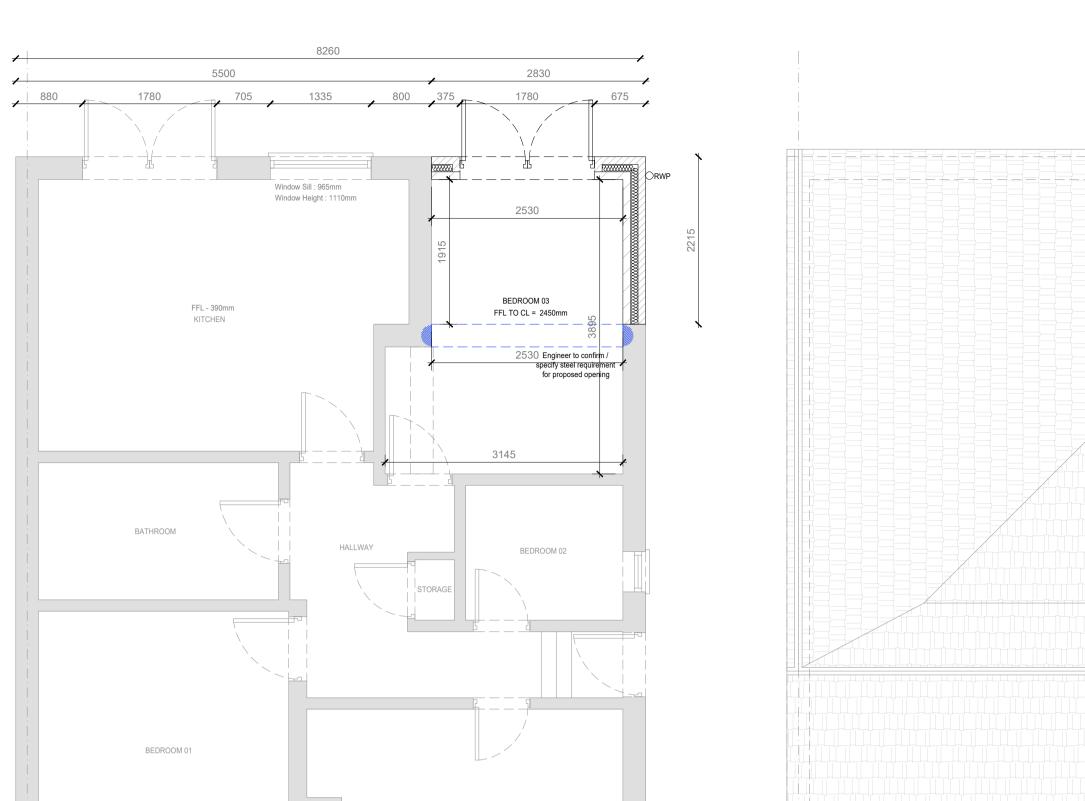
- Do not Scale off Drawings.

- All dimensions to be checked by contractor on-site. - Construction must only commence once planning, building control and any other relevant approvals have been obtained.
- It is the responsibility of the owner to ensure approvals have been granted.
- Any discrepancies must be reported to the architect,
- surveyor, engineer or responsible person immediately. - The contractor is responsible for ensuring compliance with the cdm regulations and mandatory h&s on site
- precautions. - The client/building owner must obtain the necessary party wall agreements prior to commencing works on

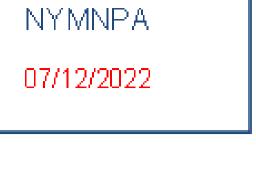


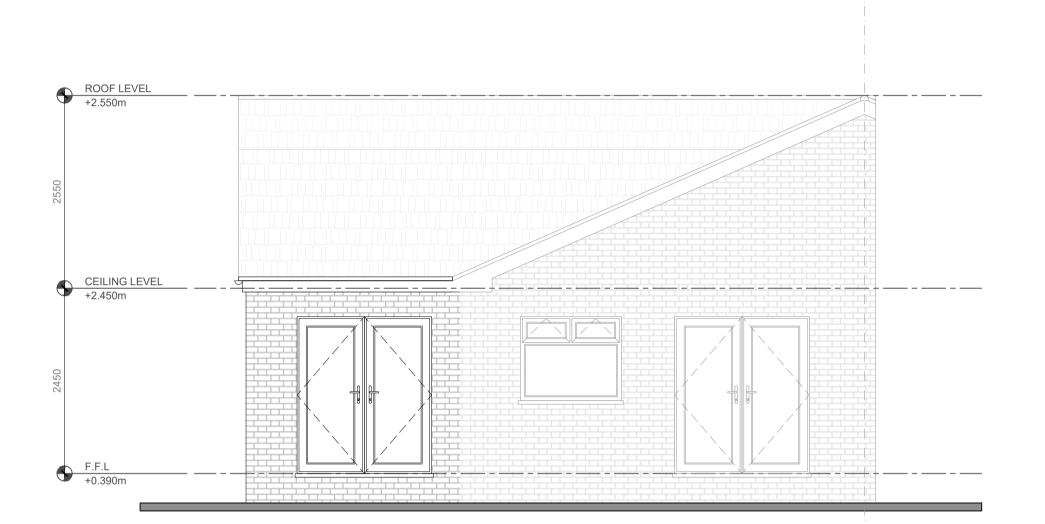


WEBSITE: WWW.PYRAMIDDESIGNS.CO.UK PHONE: 01642 280 339 EMAIL: info@pyramiddesigns.co.uk



LIVING ROOM






PROPOSED GROUND FLOOR PLAN SCALE 1:50

PROPOSED ROOF PLAN SCALE 1:50

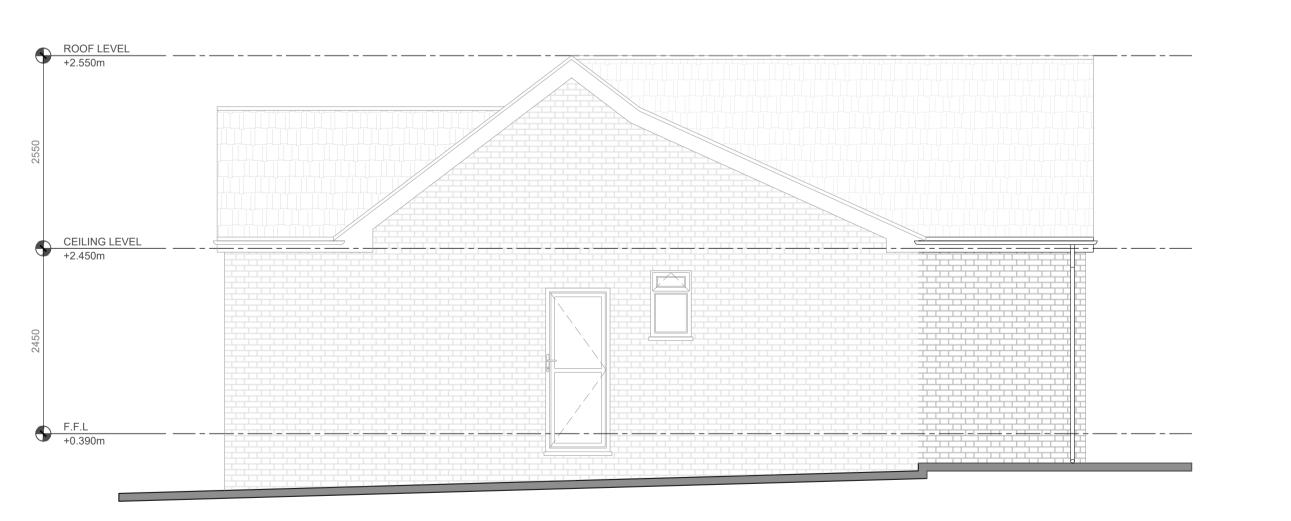PROPOSED REAR ELEVATION SCALE 1:50



PROPOSED LEFT SIDE ELEVATION SCALE 1:50

Rain flow

LEGEND

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DRAWINGS:

Proposed Plans - Page 02

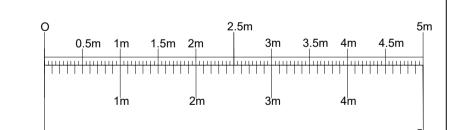
DATE:

11/10/22

SCALE:

1:50:100 @A1

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