

Site Plan

Scale 1:1250

NYMNPA

10/08/2023



Block Plan

Scale 1:200

Ordnance Survey Licence No. 100002562

BHD Design Ltd Airy Hill Manor Whitby North Yorks YO21 1QB

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DRAWING TITLE:

Location and Block Plan

DRAWING NR: D12540-01

REV:

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10/08/2023

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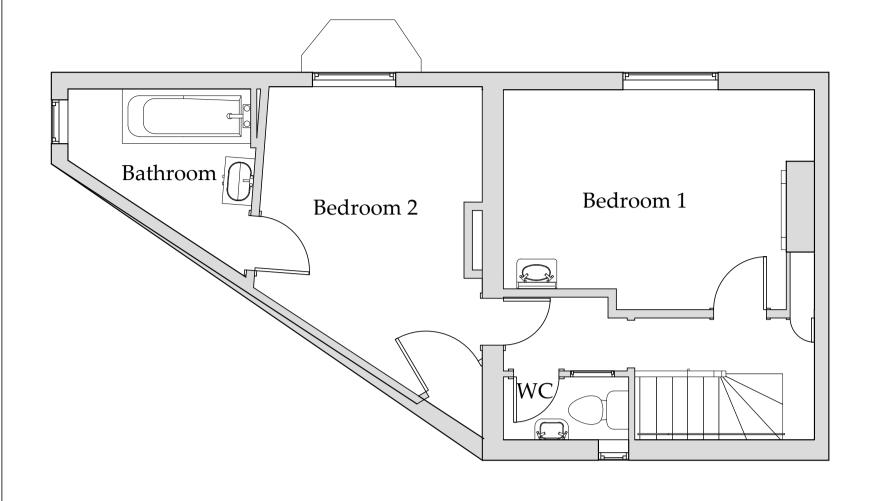
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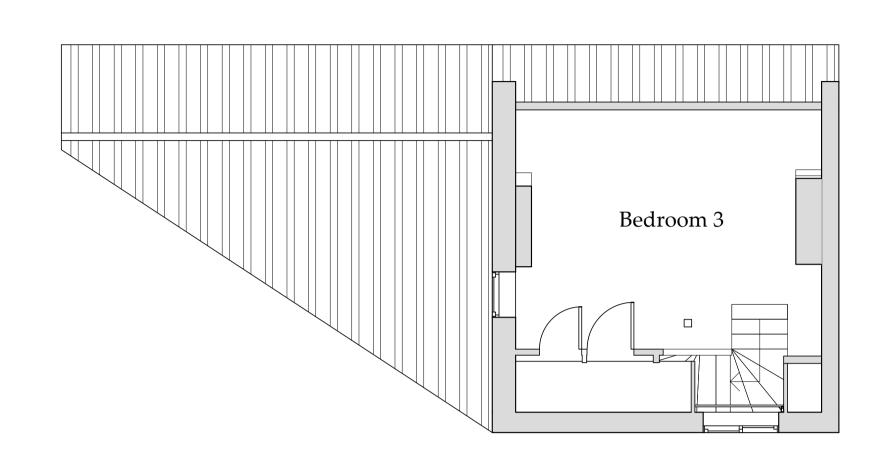
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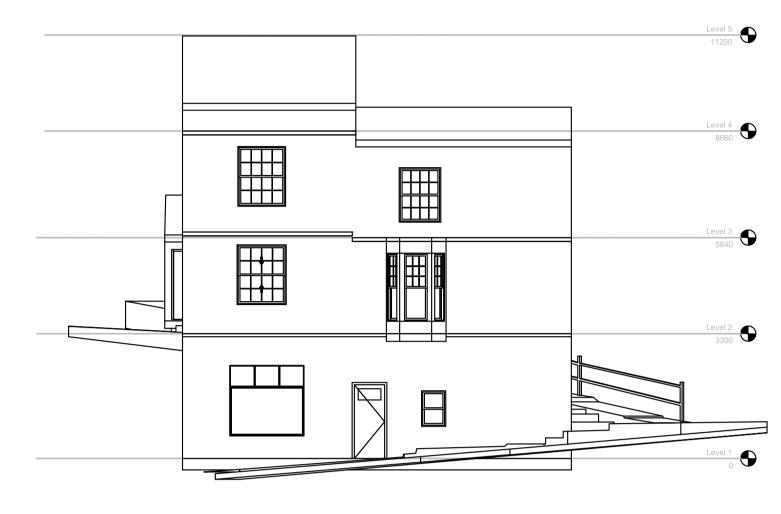
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CDM Regulations

CDM Regulations
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Contractor must agree the 'Principle Contractor' roll with the client prior to commencement of the works.
Ensure if required under CDM2015 regulations that the project is notified to the HSE.







Existing Front Elevation


Scale 1:100

First Floor Plan

Scale 1:50


Second Floor Plan

Scale 1:50

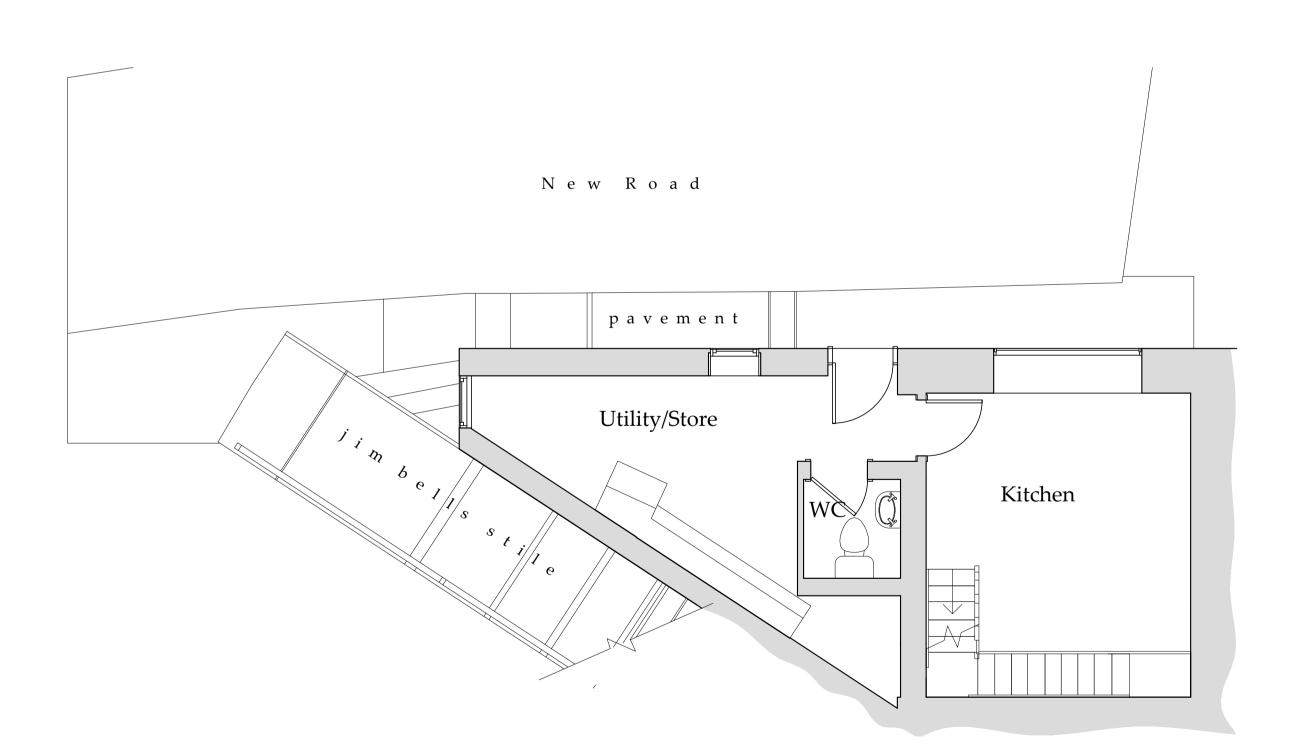

Lower Ground Floor Plan

Scale 1:50

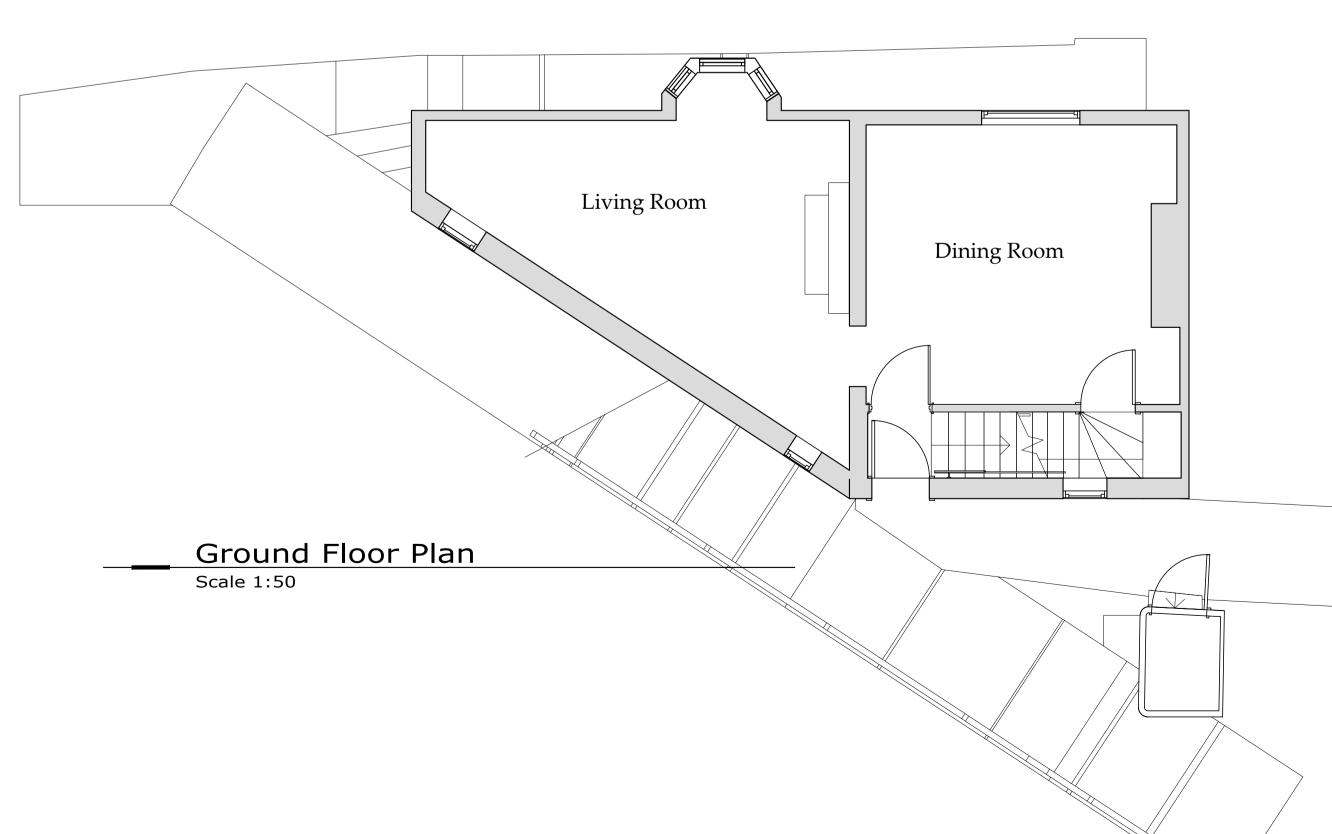

Drawings for planning and client consideration only

Survey drawings provided by client

С	04/08/23	CE	Elevation added
В	22/05/23	CE	Updated
Α	13/03/23	NID	Issue for approval
REV	DATE	BY	AMENDMENT
	13/03/23		Issue for approval

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Jackie and Rob Wallace

Refurbishnment of Burleigh Cottage RHB YO22 4SS

Existing
Floor Plans
Pre App Information only

 DRAWING STATUS:

 Pre application


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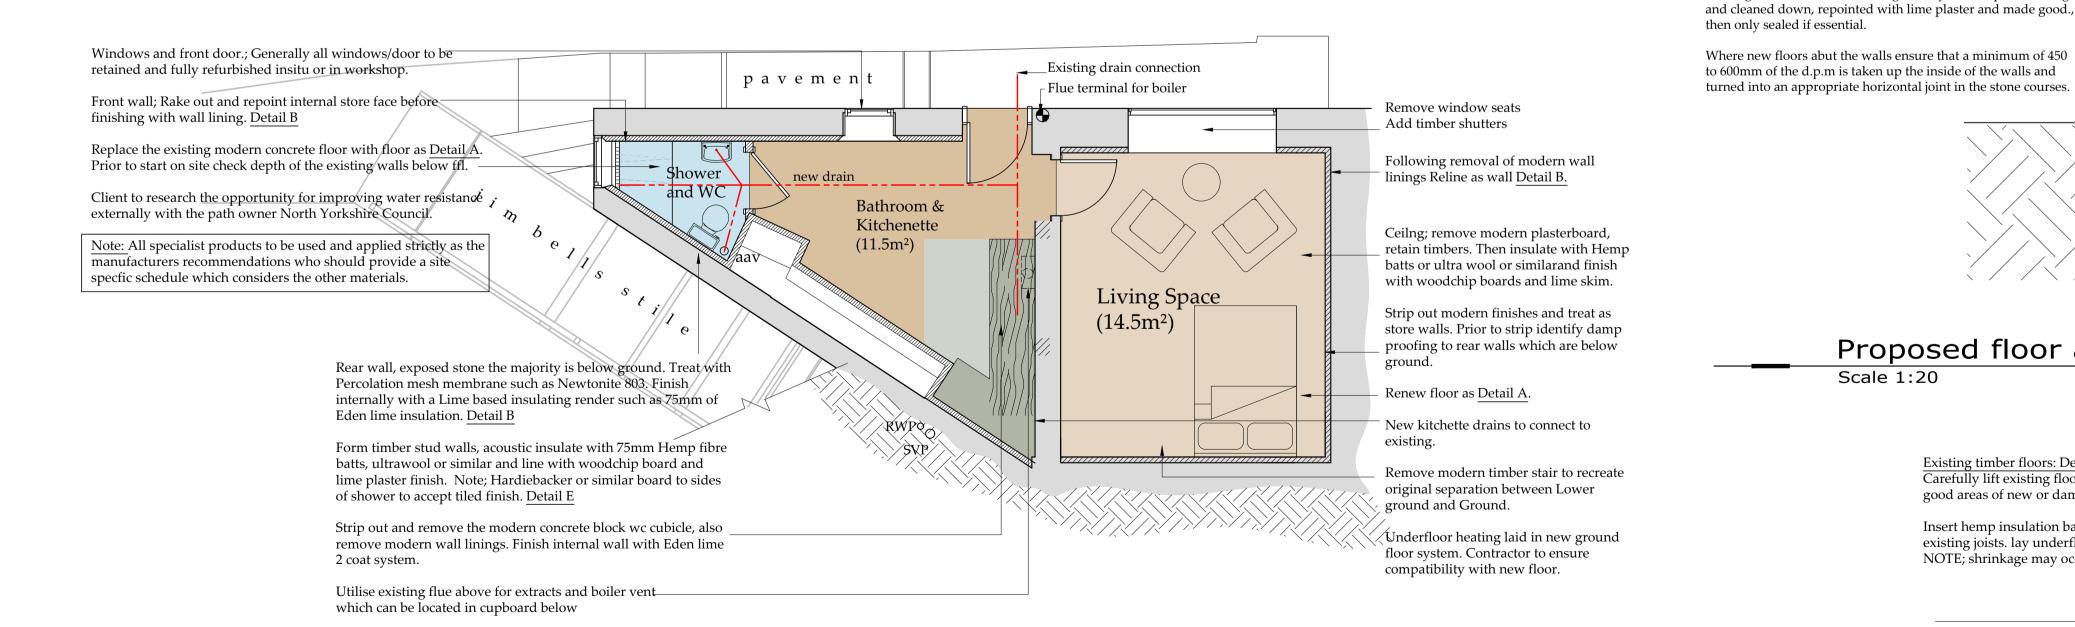
 1:50 @ A1
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New Road





Lower Ground Floor Plan (George James Cottage)

Scale 1:50

NYMNPA

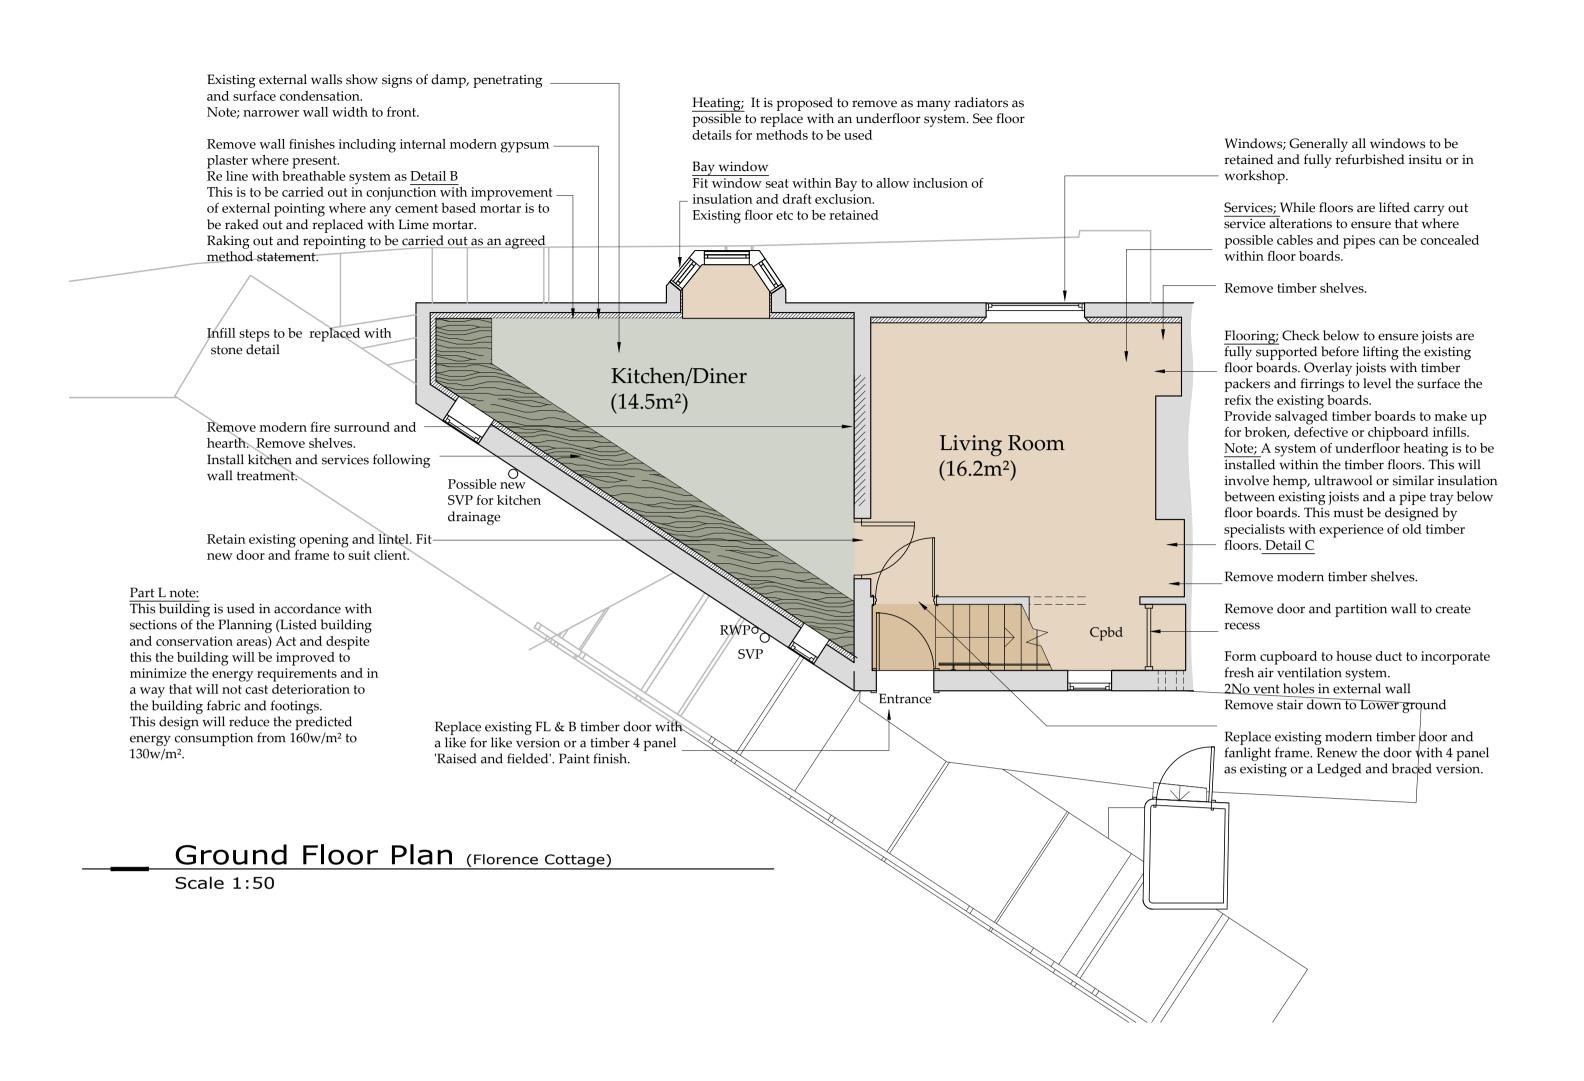10/08/2023

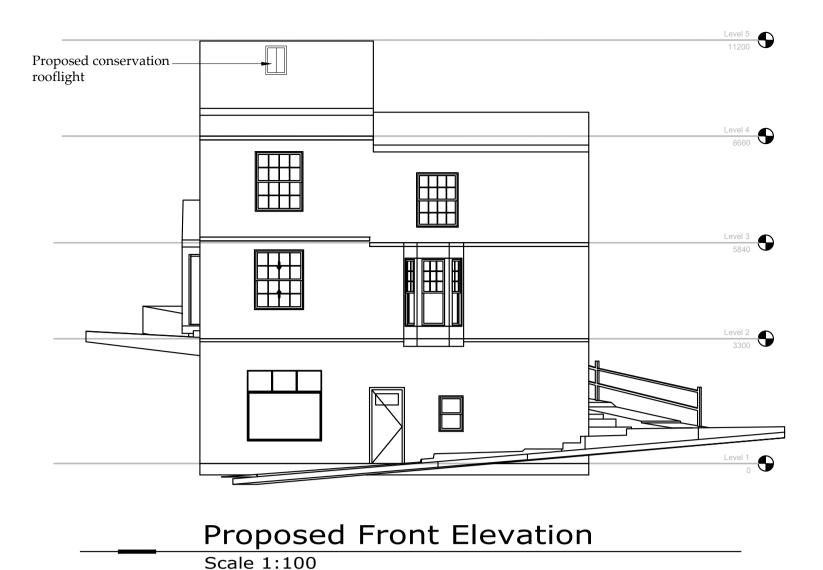

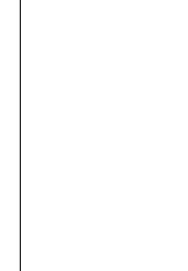

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Survey drawings provided by client

and maintaining a dry slab • 40mm thick corkboard edge insulation as an upstand 100mm high around the perimeter of each room to which the limecrete slab abuts. • 290mm thick GLAPOR SG600 RFG (reinforced foam glass) forms an insulated layer combining an engineering base, wicking break and moisture buffering. • Laid on a geotextile wrapped up and around the perimeter edges and below the geotextile above. This being laid on the subsoil/substrata. If required construct external land drain system and trench plus GLAPOR SG600 RFG system to perimeter of walls. Note: Clients and Contractor to liaise with materials supplier for specification that is required to achieve a U value of 0.18w/m²/k. Note drain to perimeter and the underfloor heating pipework to be incorporated Floor to be finished with a stone tile surface

Insulated floor system: Detail A

This is based on the 'Sublime' Insulated Floor System

recommended by Ty Mawr suppliers pf materials for use in old

• 100mm thick Limecrete slab providing moisture buffering

Proposed floor and wall treatment Detail A & B

Scale 1:20

Wall Insulation: Detail B

using lime mortar.

Superfine Plaster.

Clean down internal face of walls and repoint where necessary

Construct 50mm x 50mm tanilised timber lining walls insulated

using 50mm Themafleece Cosywool/Ultrawool/NatraHemp

between frame, 15mm Celenit Woodfibre board to inner face.

Attach mesh for lime plaster finish using 2 coats Fine Hemp

plaster plus mesh and 1 no. top coat of 3mm internal finish or

plaster with 1 no. top coat of 3mm CAL finishing plaster.

Alternatively use 1 no. coat 10mm thick REBOCO (meshed) lime

At window and door reveals it is recommended that where

Existing internal stone walls are generally to be kept as existing

and cleaned down, repointed with lime plaster and made good.,

turned into an appropriate horizontal joint in the stone courses.

practical 50mm thick Homatherm wood fibreboard or 25mm


Celenit wood wool board plus mesh and 2 coats 6mm lime

plaster and 1 coat of 3mm fine lime topcoat.

25mm cavity with Tyvek vapour membrane fixed to wall.

Existing timber floors: Detail C Carefully lift existing floorboards and save for reuse. Obtain reclaimed timber for making good areas of new or damaged flooring. Some current areas are chipboard.

Insert hemp insulation batts, ultra wool or similar before fixing steel pipe trays between existing joists. lay underfloor heating pipes in trays then refit timber floorboards. NOTE; shrinkage may occur to timber boards

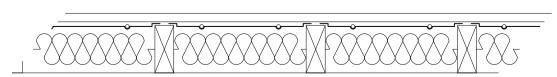

Suspended timber floor Detail C Scale 1:10

D 04/08/23 CE Altered to suit clients C 22/06/23 nid Various client detail B 22/05/23 CE Information added A 13/03/23 NID Issue for approval BHD Design Ltd Airy Hill Manor Whitby

North Yorks YO21 1QB Tel: 01947604871 E: enquiries@bhddesign.co.uk

Jackie and Rob Wallace


Refurbishnment of Burleigh Cottage RHB YO22 4SS

Proposed Lower ground and ground Floor Plans

DRAWING STATUS: **Preliminary** NID SCALE @ SIZE: 1:50 @ A1 09/03/23

D12540-04

D

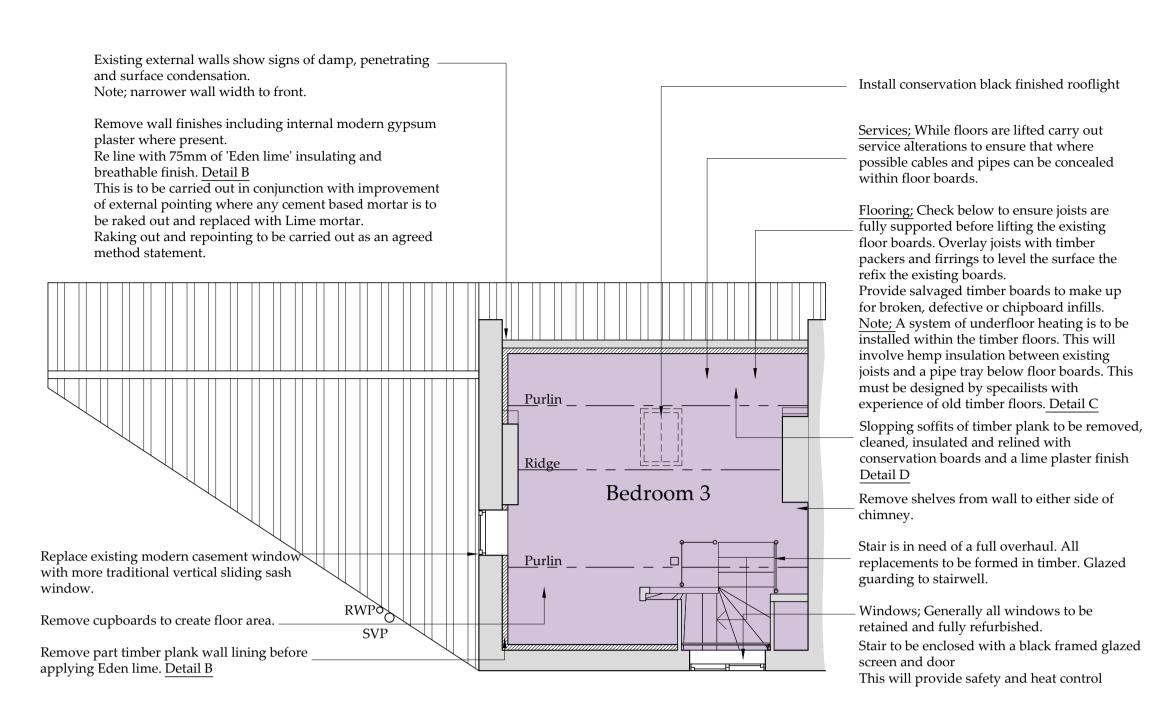

Services; While floors are lifted carry out service alterations to ensure that where possible cables and pipes can be concealed Service alterations to ensure that where possible cables and pipes can be concealed new cast iron.

Stair is in need of a full overhaul. All replacments to be formed in timber. Make

good existing guarding to landing.

External joinery to be painted with heritage colour 'Stiffkey blue' Matt (Farrow and Ball)


Black painted- Matt

<u>Heating;</u> It is proposed to remove as many radiators as possible to replace with an underfloor system. See floor details for methods to be used

Replacement skirtings and architraves to be natural timber finish, oiled

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Roof insulation: Detail D

Ensure 50mm air gap between underside of tiles and insulation. Insulate between rafters with 50mm Themafleece Cosywool/Ultrawool/NatraHemp between frame, underdraw with 15mm Celenit Woodfibre board and attach mesh for lime plaster finish using 2 coats Fine Hemp plaster plus mesh and 1 no. top coat of 3mm internal finish or Superfine Plaster.

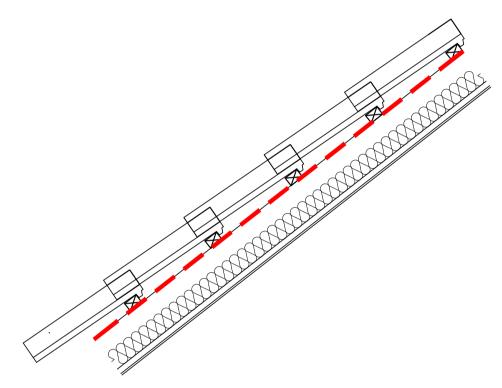Alternatively use 1 no. coat 10mm thick REBOCO (meshed) lime plaster with 1 no. top coat of 3mm CAL finishing plaster.

Rafter size assumed to be 100mm deep, once existing roof covering striped back and rafters exposed to confirm depth if less than 100mm BHD to confirm construction.

Roof detail Detail D

Scale 1:10

Stud Wall: Detail E
Construct 50mm x 50mm tanilised timber stud walls insulated using 75mm Themafleece
Cosywool/Ultrawool/NatraHemp between frame,
15mm Celenit Woodfibre board to both faces. Attach mesh for lime plaster finish using 2 coats Fine Hemp plaster plus mesh and 1 no. top coat of 3mm internal finish or Superfine Plaster.
Alternatively use 1 no. coat 10mm thick REBOCO (meshed) lime plaster with 1 no. top coat of 3mm CAL finishing plaster.

Proposed stud wall Detail E

Scale 1:10

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С В А	04/08/23 23/06/23 23/05/23	CE nid CE	Altered to suit clients Various client details Issue for approval			

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Jackie and Rob Wallace

PROJECT:

Refurbishnment of Burleigh Cottage RHB YO22 4SS

Proposed
First and second
Floor Plans

DRAWING STATUS:

Preliminary

DRAWN:

NID

SCALE @ SIZE:

DATE:

1:50 @ A1 09/03/23

DRAWING No: REV:

D12540-05

details for methods to be used Remove wall finishes including internal modern gypsum -Windows; Generally all windows to be plaster where present. retained and fully refurbished insitu or in Re line as Detail B workshop. This is to be carried out in conjunction with improvement of external pointing where any cement based mortar is to Services; While floors are lifted carry out be raked out and replaced with Lime mortar. service alterations to ensure that where Raking out and repointing to be carried out as an agreed possible cables and pipes can be concealed method statement. within floor boards. <u>Flooring</u>; Check below to ensure joists are fully supported before lifting the existing floor boards. Overlay joists with timber packers and firrings to level the surface the refix the existing boards. Provide salvaged timber boards to make up Bathroom for broken, defective or chipboard infills. Note; A system of underfloor heating is to be Bedroom 1 Bedroom 2 installed within the timber floors. This will $(10.5m^2)$ involve hemp insulation between existing $(11m^2)$ newSVP joists and a pipe tray below floor boards. This Strip off tiles and modern wall finishes must be designed by specailists with before applying insulated wall lining as detail experience of old timber floors. Reduce size of Bathroom, provide new partition wall precise layout to be agreed. Detail E Existing fireplace retained Remove sink fittings and pipework and make Slopping soffits of timber plank to be removed, cleaned, insulated and relined with conservation boards and a lime plaster finish Detail D Retain door and subdivide cupboard. Wall lining Detail B-RWP Rebuild recent stud partition and refurbish the wc room. Replace borrowed light, insert Remove cupboard, incorporate space into room glass to clients design, possibly stained glass. Sliding door, whb above/on cistern, shower to left of the room Form cupboard to house duct to incorporate Note: All specialist products to be used and applied strictly as the fresh air ventilation system. manufacturers recommendations who should provide a site 2No holes in external wall for ventilation specfic schedule which considers the other materials.

Heating; It is proposed to remove as many radiators as

possible to replace with an underfloor system. See floor

First Floor Plan

Second Floor Plan

Scale 1:50

Existing external walls show signs of damp, penetrating

and surface condensation.

Note; narrower wall width to front.

Scale 1:50