




First Floor Plan
Scale 1:50


Second Floor Plan
Scale 1:50

Existing Front Elevation

Scale 1:100

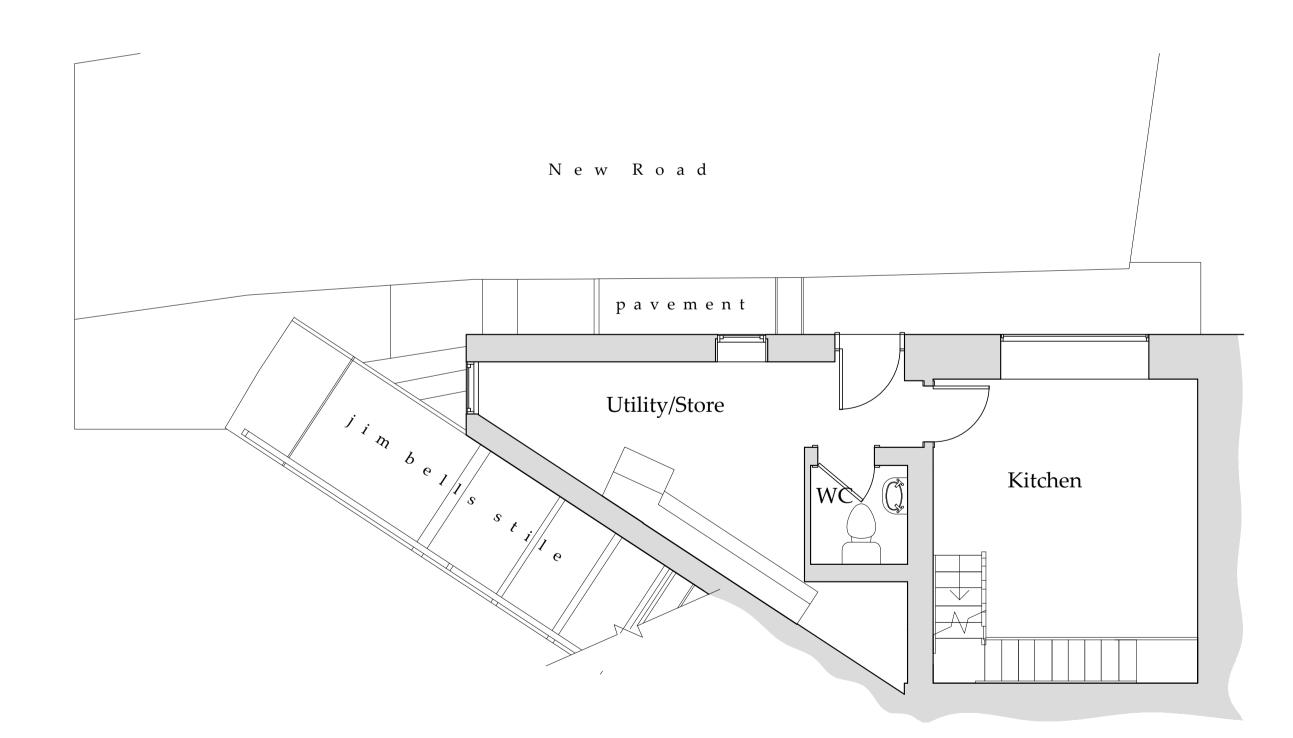

Lower Ground Floor Plan
Scale 1:50

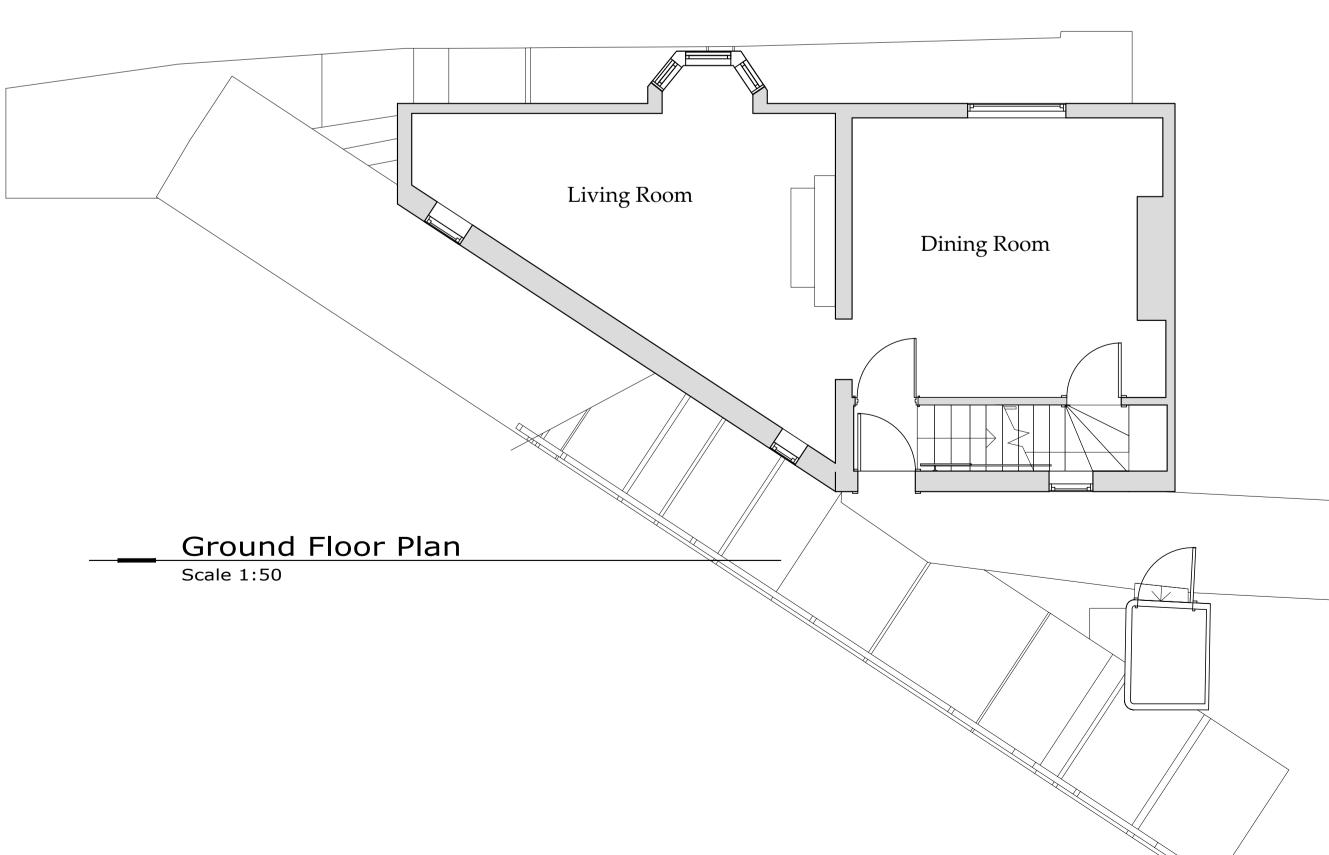

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CDM Regulations

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Contractor must agree the 'Principle Contractor' roll with the

NYMNPA

client prior to commencement of the works.
Ensure if required under CDM2015 regulations that the project is

notified to the HSE.

30/08/2023

AMENDED

Drawings for planning and client consideration only

Survey drawings provided by client

C 04/08/23 CE Elevation added
B 22/05/23 CE Updated
A 13/03/23 NID Issue for approval
REV DATE BY AMENDMENT

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Jackie and Rob Wallace

Refurbishnment of Burleigh Cottage RHB YO22 4SS

Existing
Floor Plans
Pre App Information only

 DRAWING STATUS:

 Pre application


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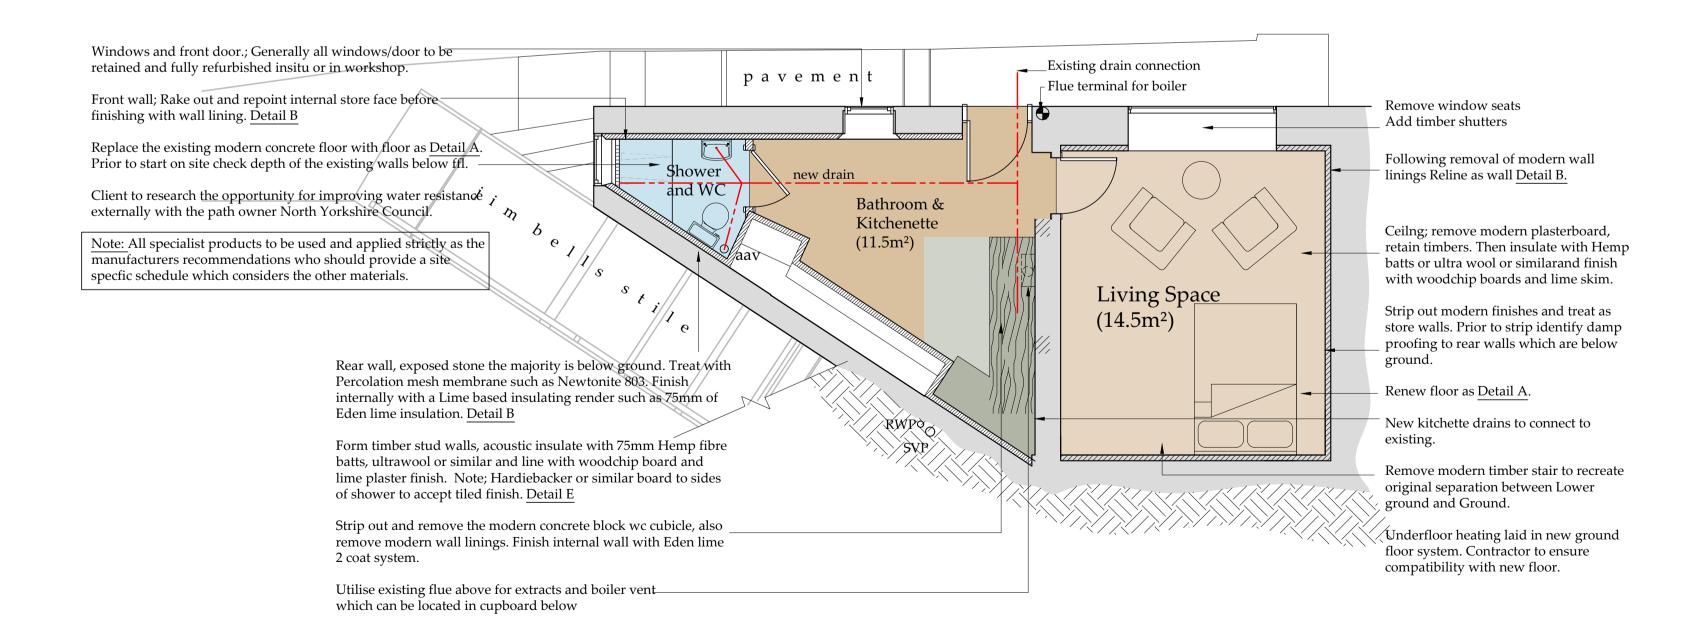
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 09/03/23

 DRAWING No:
 REV:

 D12540-03
 C



New Road

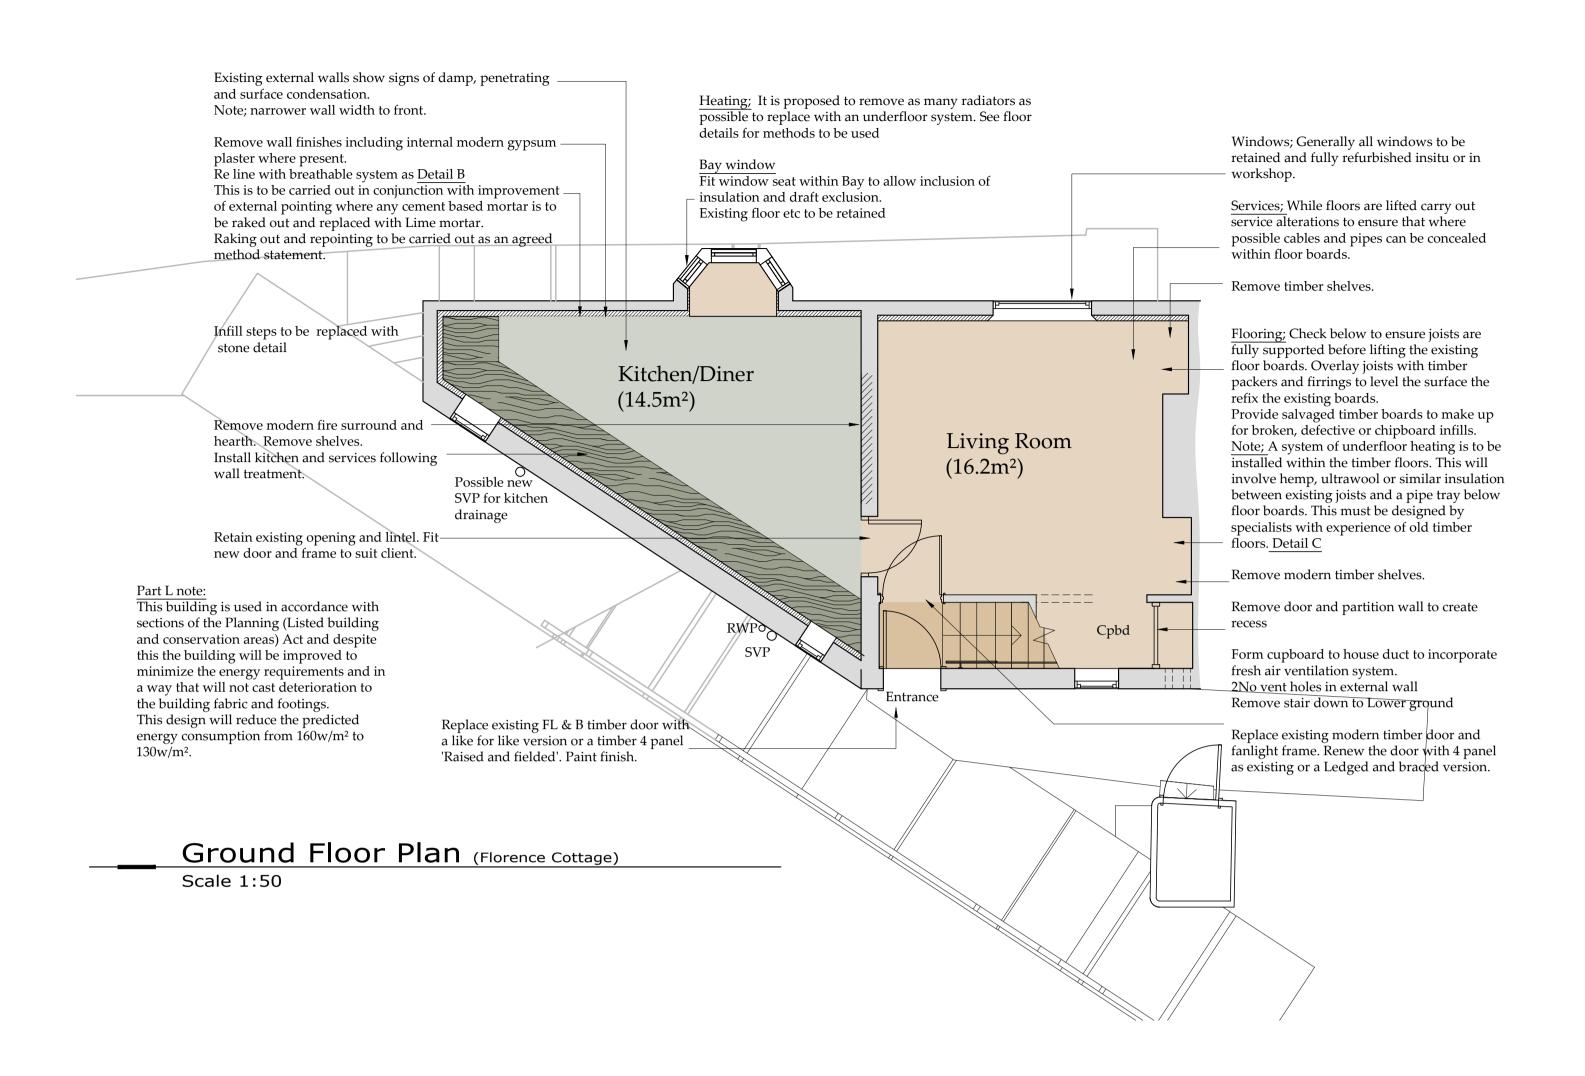

Lower Ground Floor Plan (George James Cottage)

Scale 1:50



This is based on the 'Sublime' Insulated Floor System recommended by Ty Mawr suppliers pf materials for use in old Wall Insulation: Detail B Clean down internal face of walls and repoint where necessary • 100mm thick Limecrete slab providing moisture buffering using lime mortar. and maintaining a dry slab 25mm cavity with Tyvek vapour membrane fixed to wall. • 40mm thick corkboard edge insulation as an upstand Construct 50mm x 50mm tanilised timber lining walls insulated 100mm high around the perimeter of each room to which the using 50mm Themafleece Cosywool/Ultrawool/NatraHemp limecrete slab abuts. between frame, 15mm Celenit Woodfibre board to inner face. • 290mm thick GLAPOR SG600 RFG (reinforced foam glass) Attach mesh for lime plaster finish using 2 coats Fine Hemp forms an insulated layer combining an engineering base, plaster plus mesh and 1 no. top coat of 3mm internal finish or wicking break and moisture buffering. Superfine Plaster. • Laid on a geotextile wrapped up and around the Alternatively use 1 no. coat 10mm thick REBOCO (meshed) lime perimeter edges and below the geotextile above. plaster with 1 no. top coat of 3mm CAL finishing plaster. This being laid on the subsoil/substrata. At window and door reveals it is recommended that where practical 50mm thick Homatherm wood fibreboard or 25mm If required construct external land drain system and trench plus Celenit wood wool board plus mesh and 2 coats 6mm lime GLAPOR SG600 RFG system to perimeter of walls. plaster and 1 coat of 3mm fine lime topcoat. Note: Clients and Contractor to liaise with materials supplier for Existing internal stone walls are generally to be kept as existing specification that is required to achieve a U value of 0.18w/m²/k. and cleaned down, repointed with lime plaster and made good., Note drain to perimeter and the underfloor heating pipework to then only sealed if essential. be incorporated Where new floors abut the walls ensure that a minimum of 450 Floor to be finished with a stone tile surface to 600mm of the d.p.m is taken up the inside of the walls and turned into an appropriate horizontal joint in the stone courses.


Insulated floor system: Detail A

Proposed floor and wall treatment Detail A & B

Scale 1:20

Existing timber floors: Detail C Carefully lift existing floorboards and save for reuse. Obtain reclaimed timber for making good areas of new or damaged flooring. Some current areas are chipboard.

Insert hemp insulation batts, ultra wool or similar before fixing steel pipe trays between existing joists. lay underfloor heating pipes in trays then refit timber floorboards. NOTE; shrinkage may occur to timber boards

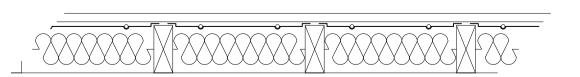

Scale 1:10

Scale 1:10

Suspended timber floor Detail C

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D 04/08/23 CE Altered to suit clients
C 22/06/23 nid Various client detail
B 22/05/23 CE Information added
A 13/03/23 NID Issue for approval

REV DATE BY AMENDMENT

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Refurbishnment of Burleigh Cottage RHB YO22 4SS

Proposed

Lower ground and ground

Floor Plans

 DRAWING STATUS:

 Preliminary


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 09/03/23

D12540-04

D



General Notes All rainwater and SVP's to be replaced with new cast iron. Black painted- Matt

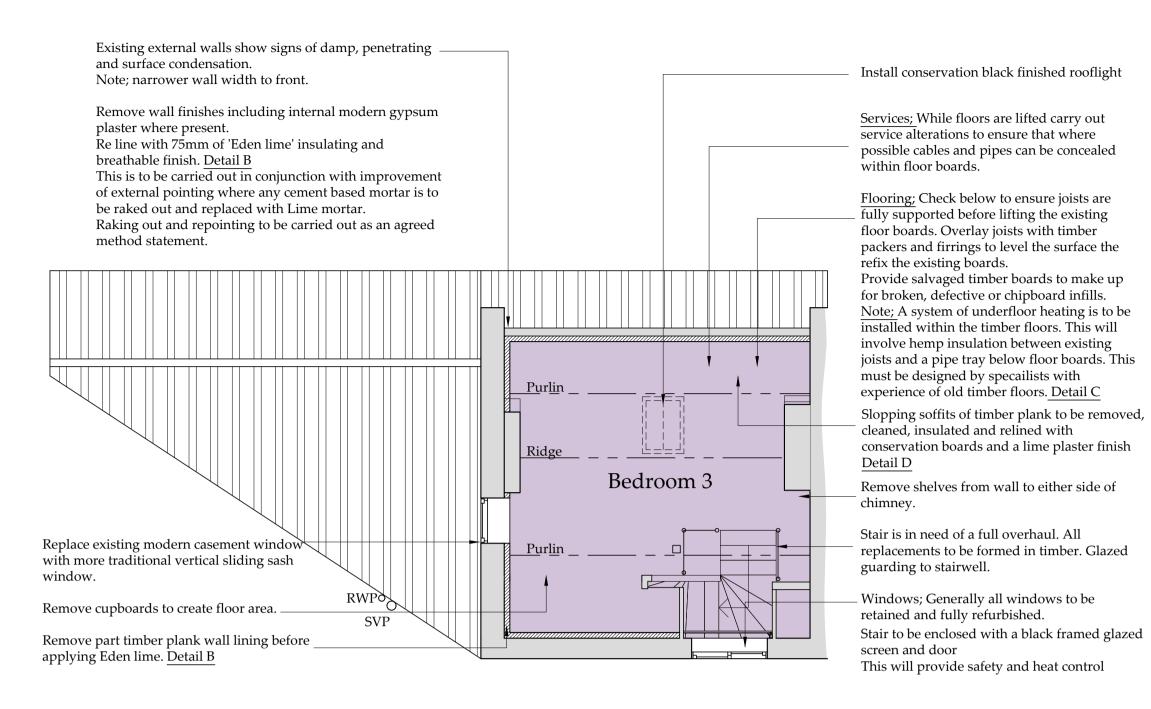External joinery to be painted with heritage colour 'Stiffkey blue' Matt (Farrow and Ball)

Heating; It is proposed to remove as many radiators as possible to replace with an underfloor system. See floor details for methods to be used

Replacement skirtings and architraves to be natural timber finish, oiled

Roof insulation: Detail D


Ensure 50mm air gap between underside of tiles and insulation. Insulate between rafters with 50mm Themafleece Cosywool/Ultrawool/NatraHemp between frame, underdraw with 15mm Celenit Woodfibre board and attach mesh for lime plaster finish using 2 coats Fine Hemp plaster plus mesh and 1 no. top coat of 3mm internal finish or Superfine

Alternatively use 1 no. coat 10mm thick REBOCO (meshed) lime plaster with 1 no. top coat of 3mm CAL finishing plaster.

Rafter size assumed to be 100mm deep, once existing roof covering striped back and rafters exposed to confirm depth if less than 100mm BHD to confirm construction.

Roof detail Detail D

Scale 1:10

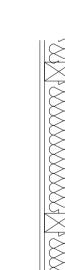

Stud Wall: Detail E Construct 50mm x 50mm tanilised timber stud walls insulated using 75mm Themafleece Cosywool/Ultrawool/NatraHemp between frame, 15mm Celenit Woodfibre board to both faces. Attach mesh for lime plaster finish using 2 coats Fine Hemp plaster plus mesh and 1 no. top coat of 3mm internal finish or Superfine Plaster. Alternatively use 1 no. coat 10mm thick REBOCO (meshed) lime plaster with 1 no. top coat of 3mm CAL finishing plaster.

Proposed stud wall Detail E Scale 1:10

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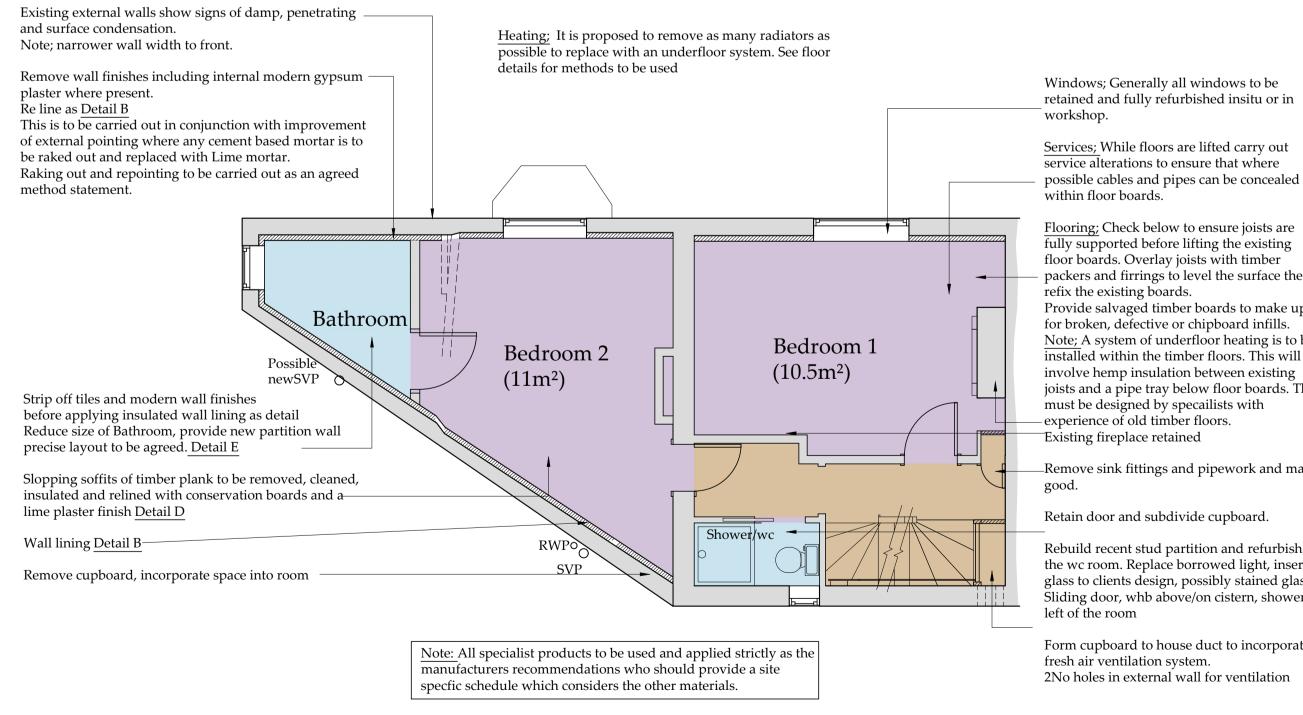
Proposed First and second Floor Plans

DRAWING STATUS: Preliminary NID SCALE @ SIZE:

1:50 @ A1

D12540-05

09/03/23



Scale 1:50

First Floor Plan

Second Floor Plan

Scale 1:50

packers and firrings to level the surface the Provide salvaged timber boards to make up for broken, defective or chipboard infills. Note; A system of underfloor heating is to be installed within the timber floors. This will involve hemp insulation between existing joists and a pipe tray below floor boards. This

Remove sink fittings and pipework and make

Rebuild recent stud partition and refurbish the wc room. Replace borrowed light, insert glass to clients design, possibly stained glass. Sliding door, whb above/on cistern, shower to

Form cupboard to house duct to incorporate

Stair is in need of a full overhaul. All replacments to be formed in timber. Make good existing guarding to landing.