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Produced on 04 May 2021 from the Ordnance Survey National Geographic Database and incorporating surveyed revision available at this date.

This map shows the area bounded by 486853 507018,486995 507018,486995 507160,486853 507160,486853 507018

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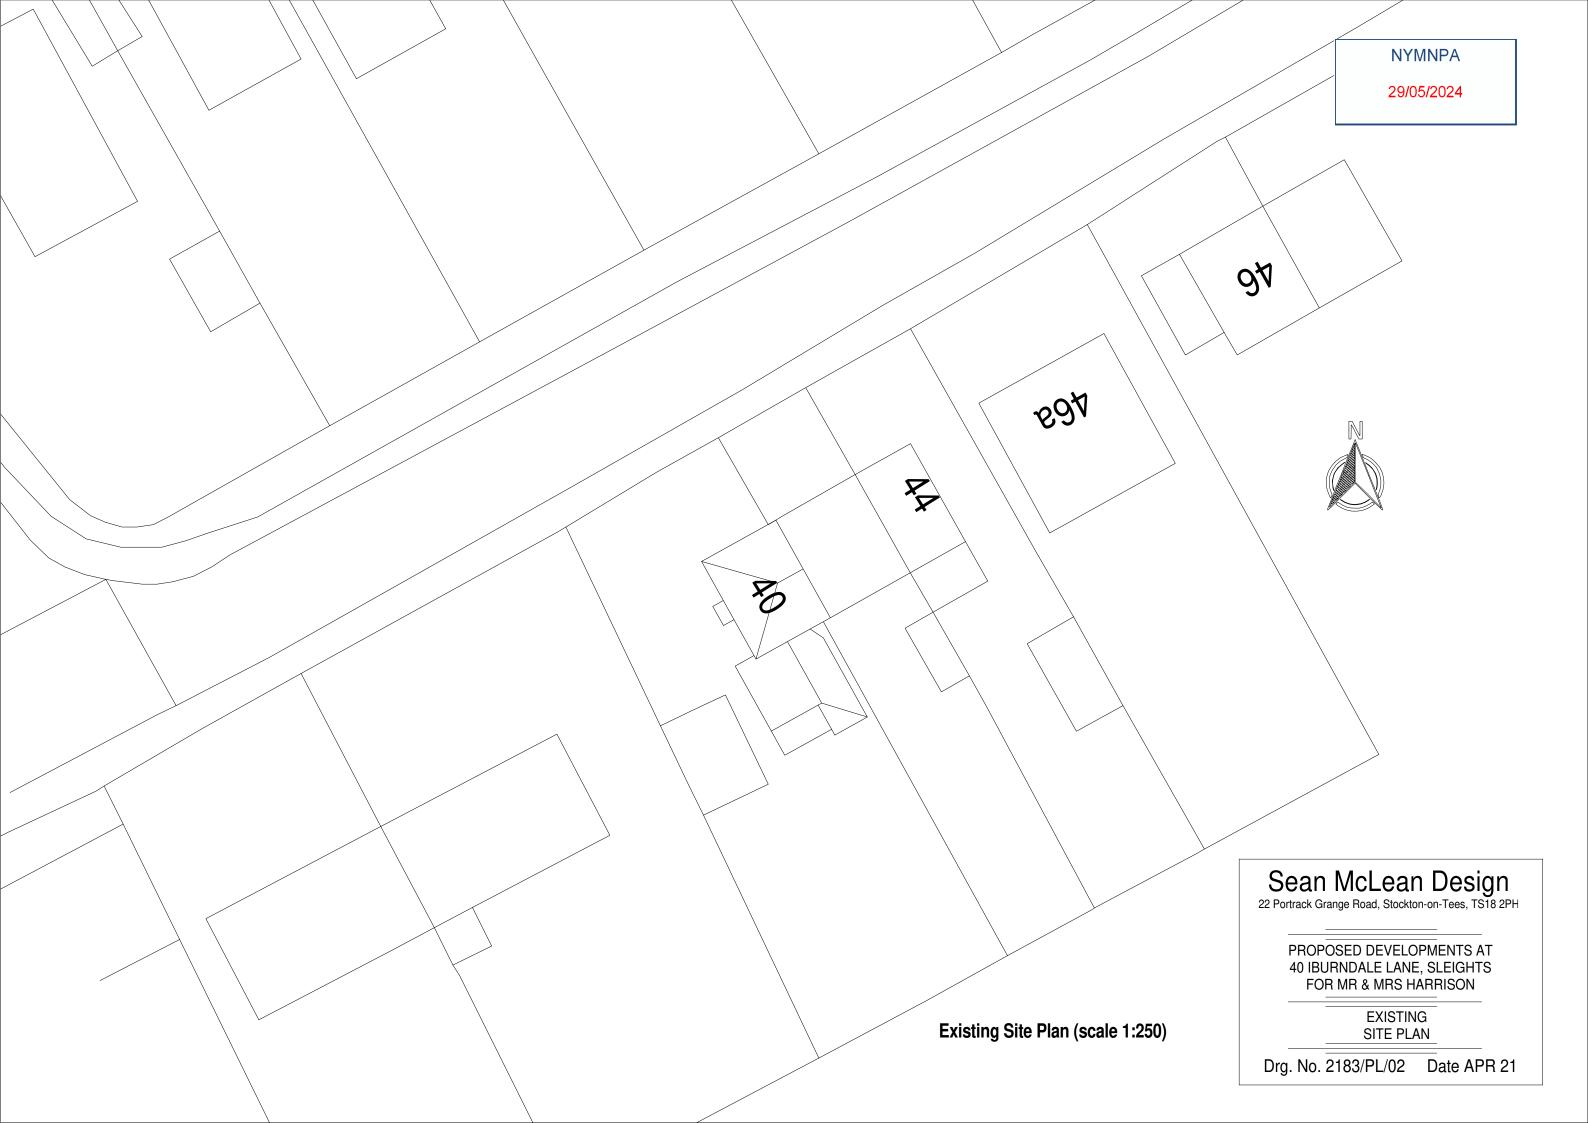
Location Plan (scale 1:1250)


Sean McLean Design 22 Portrack Grange Road, Stockton-on-Tees, TS18 2PH

PROPOSED DEVELOPMENTS AT 40 IBURNDALE LANE, SLEIGHTS FOR MR & MRS HARRISON

> **LOCATION PLAN**

Drg. No. 2183/PL/01 Date APR 21



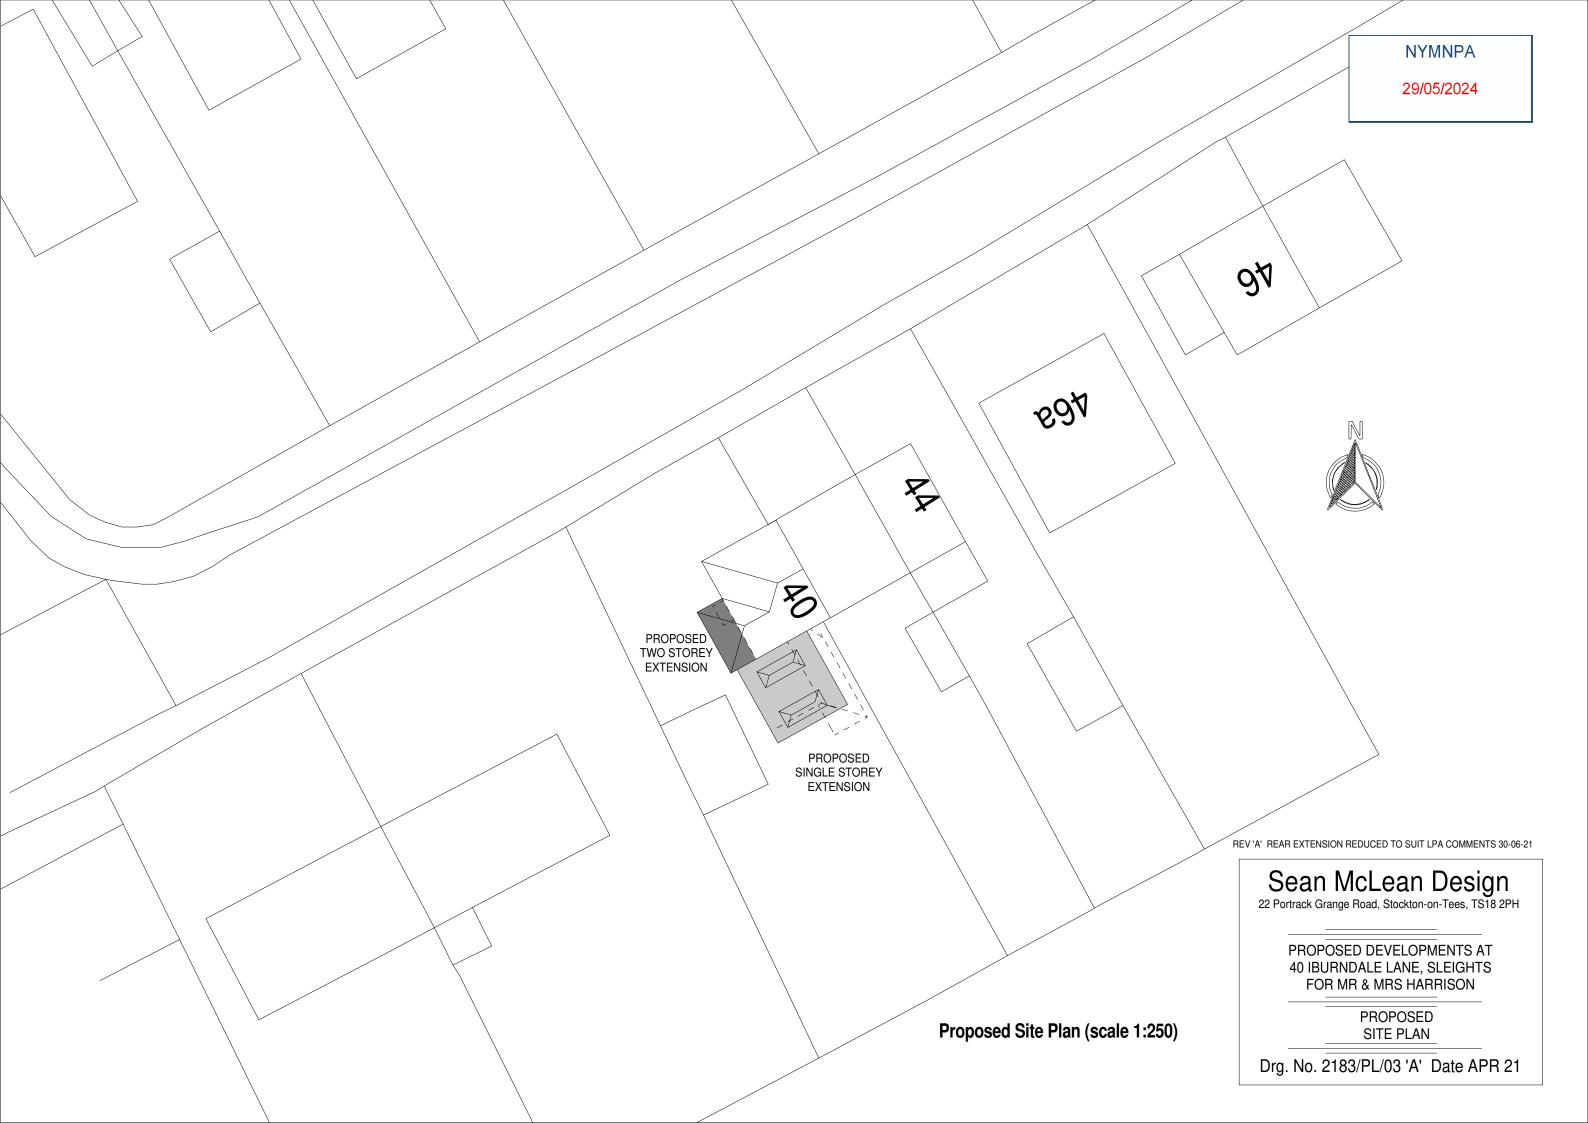




Existing North Elevation (scale 1:100)




Existing West Elevation (scale 1:100)



Existing South Elevation (scale 1:100)

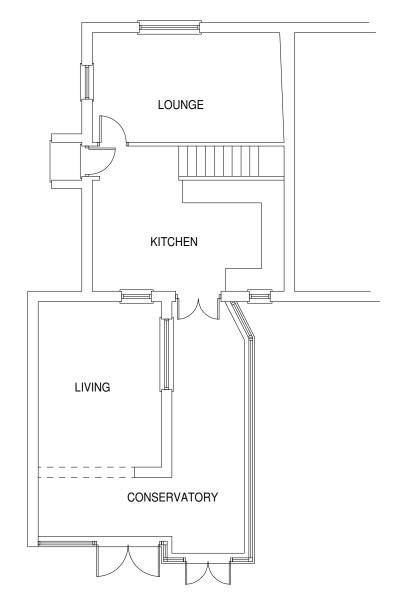


Existing Ground Floor Plan (scale 1:100)

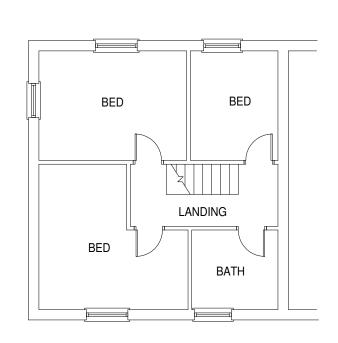

Existing First Floor Plan (scale 1:100)

NYMNPA 29/05/2024

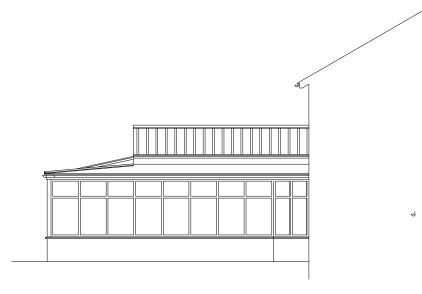


Existing East Elevation (scale 1:100)



PROPOSED DEVELOPMENTS AT 40 IBURNDALE LANE, SLEIGHTS FOR MR & MRS HARRISON

> EXISTING FLOOR PLANS AND ELEVATIONS


Drg. No. 2183/PL/04 Date APR 21

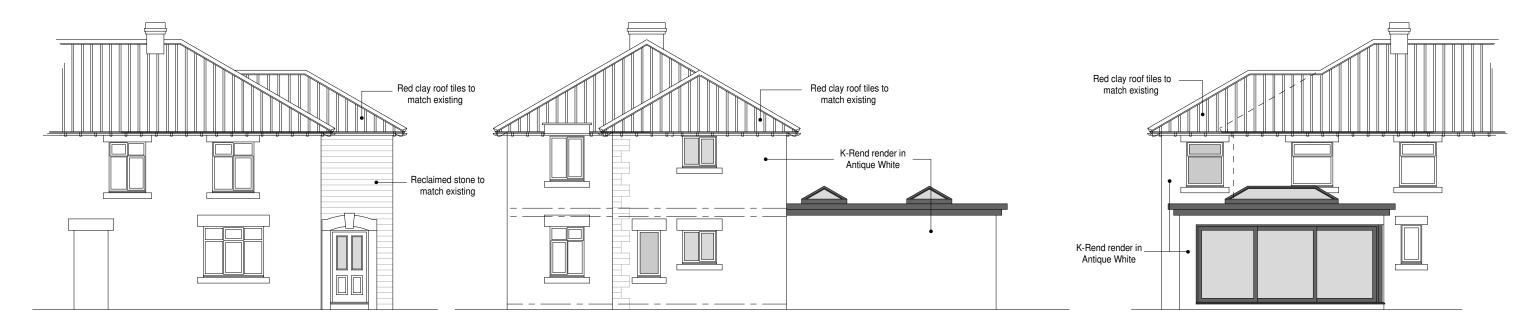

Proposed North Elevation (scale 1:100)

Proposed West Elevation (scale 1:100)


Proposed South Elevation (scale 1:100)

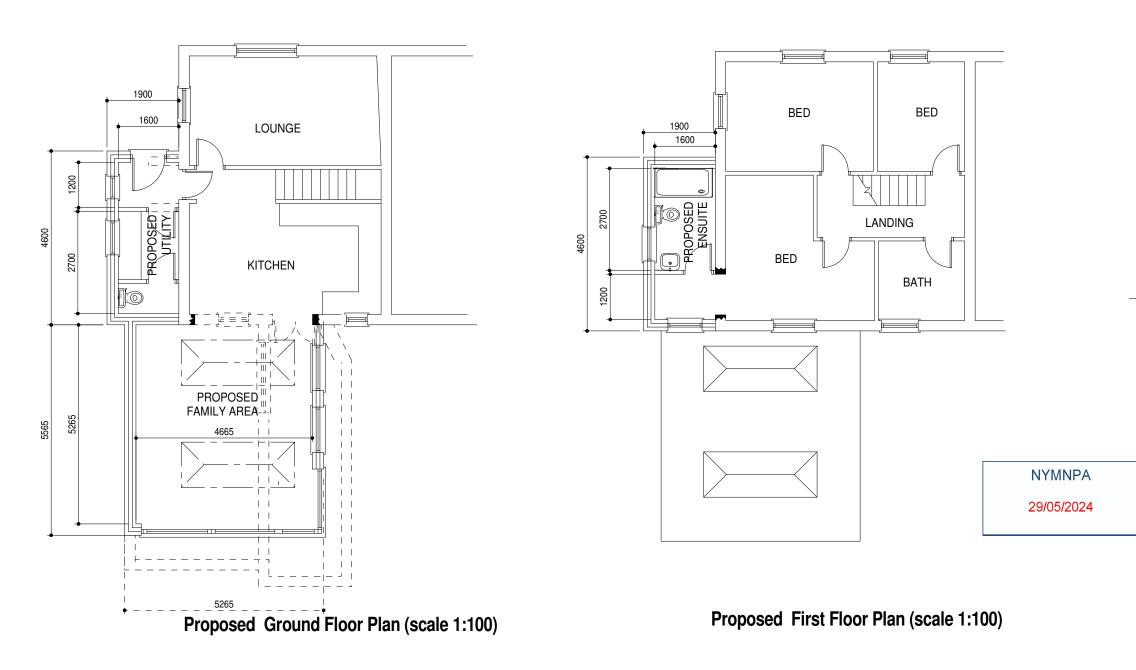

Proposed East Elevation (scale 1:100)

REV 'A' REAR EXTENSION REDUCED TO SUIT LPA COMMENTS 30-06-21




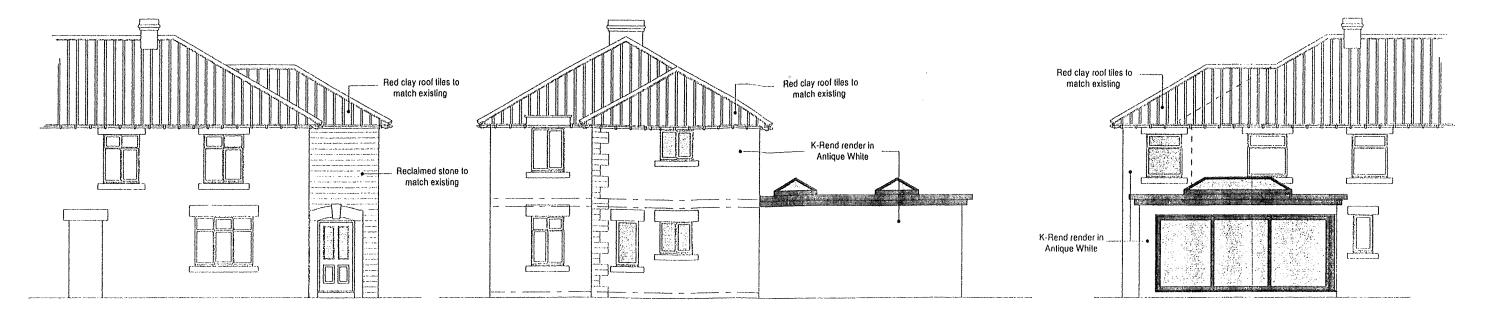


Proposed North Elevation (scale 1:100)

Proposed West Elevation (scale 1:100)

Proposed South Elevation (scale 1:100)

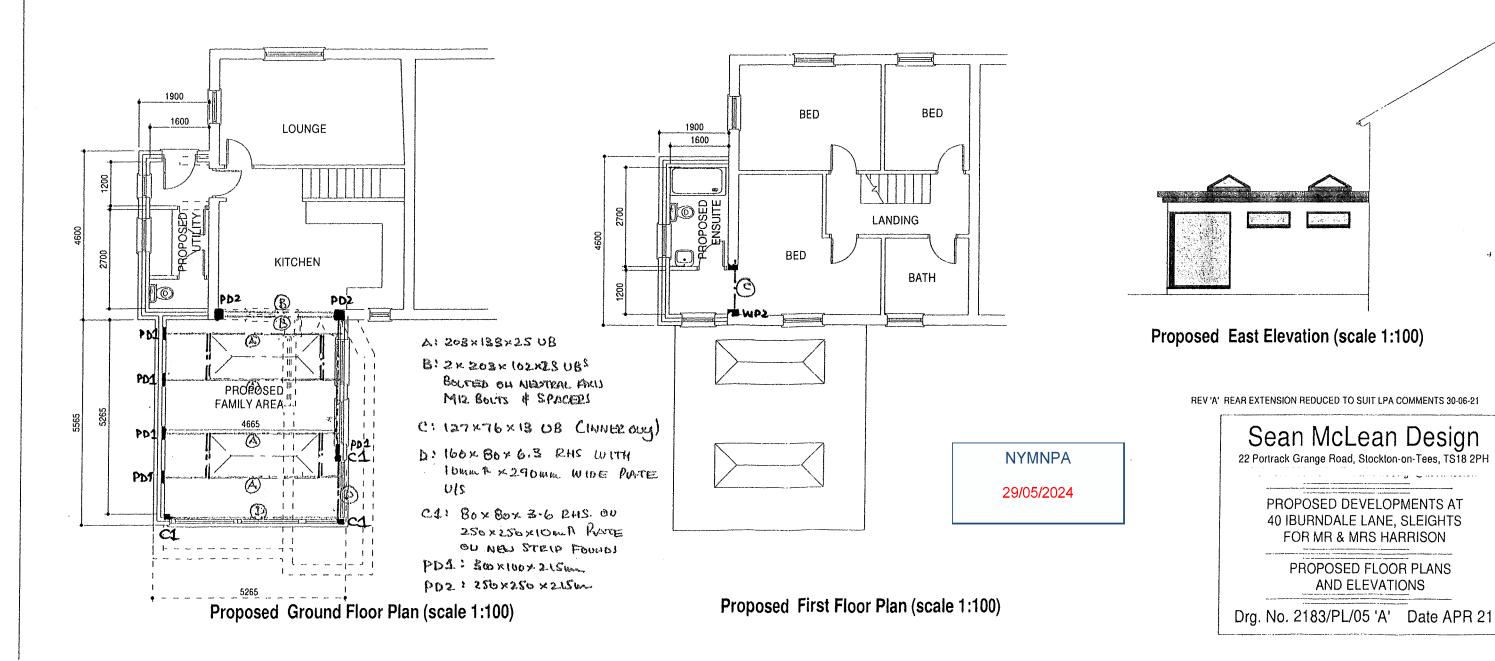

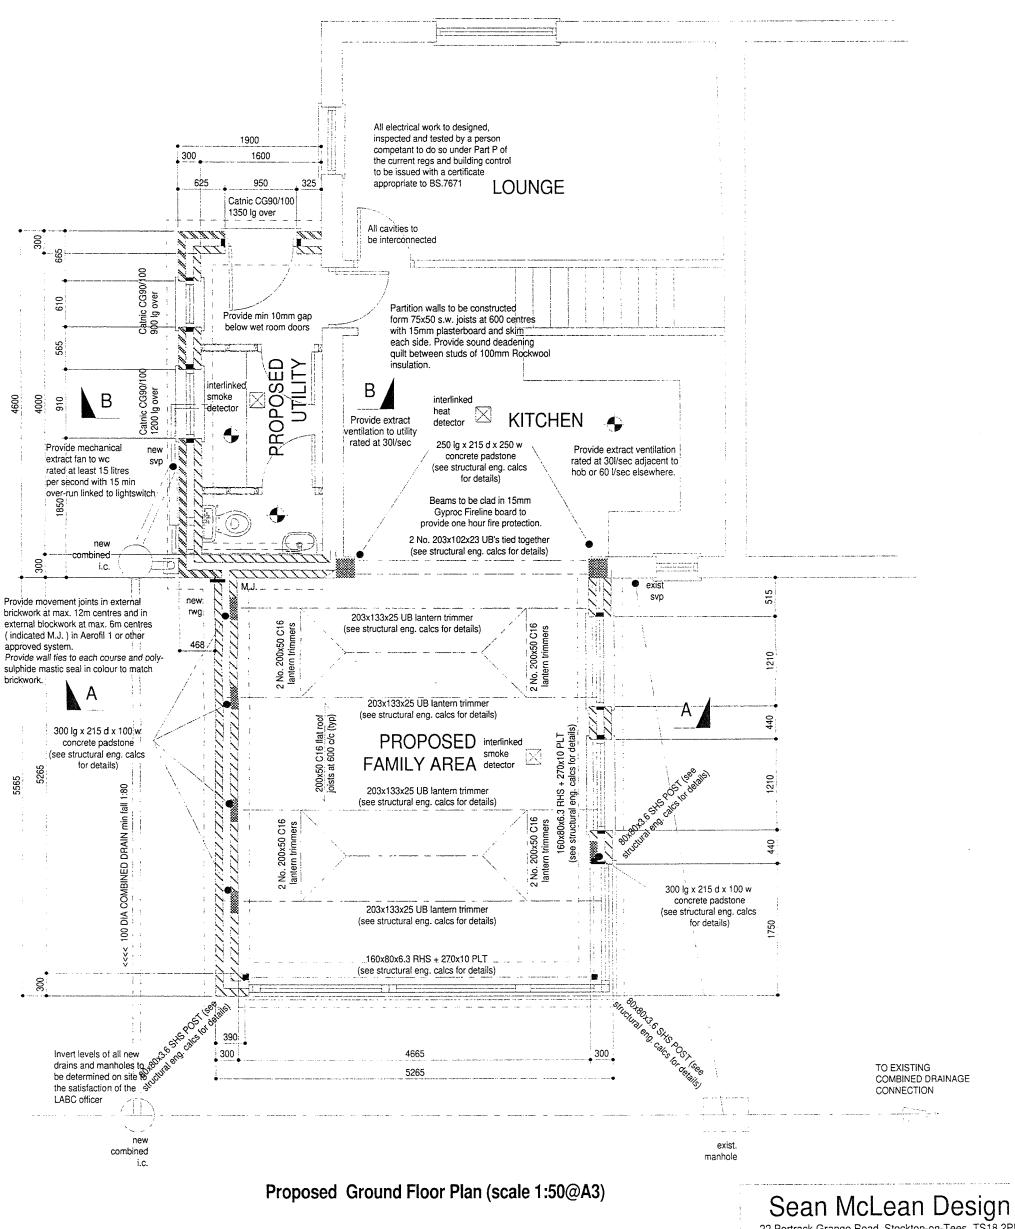

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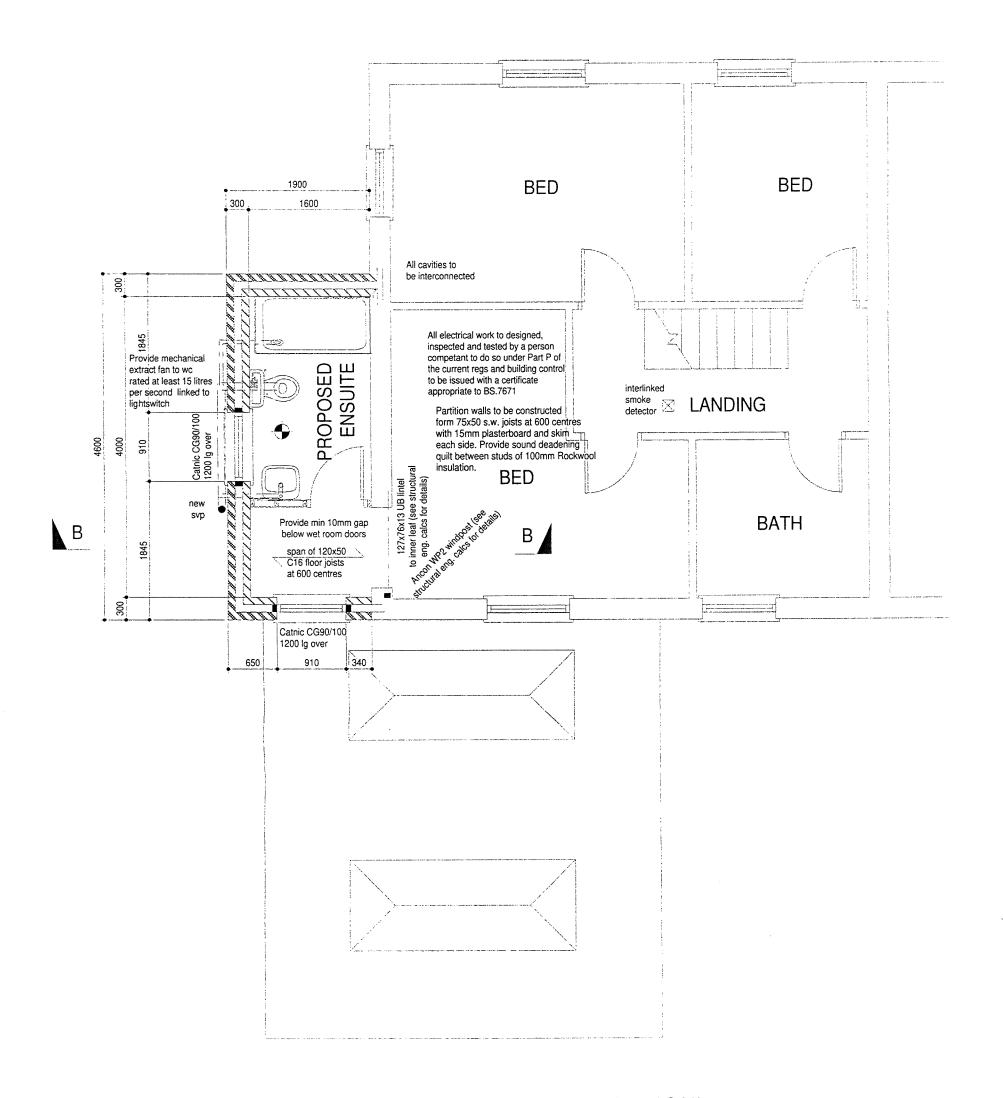
29/05/2024

22 Portrack Grange Road, Stockton-on-Tees, TS18 2PH

PROPOSED DEVELOPMENTS AT 40 IBURNDALE LANE, SLEIGHTS FOR MR & MRS HARRISON

> **ENLARGED PROPOSED GROUND FLOOR PLAN**

Drg. No. 2183/PL/06 'O' Date APR 21



Proposed First Floor Plan (scale 1:50@A3)


NYMNPA 29/05/2024

Sean McLean Design 22 Portrack Grange Road, Stockton-on-Tees, TS18 2PH

PROPOSED DEVELOPMENTS AT 40 IBURNDALE LANE, SLEIGHTS FOR MR & MRS HARRISON

> **ENLARGED PROPOSED** FIRST FLOOR PLAN

Drg. No. 2183/PL/07 'O' Date APR 21

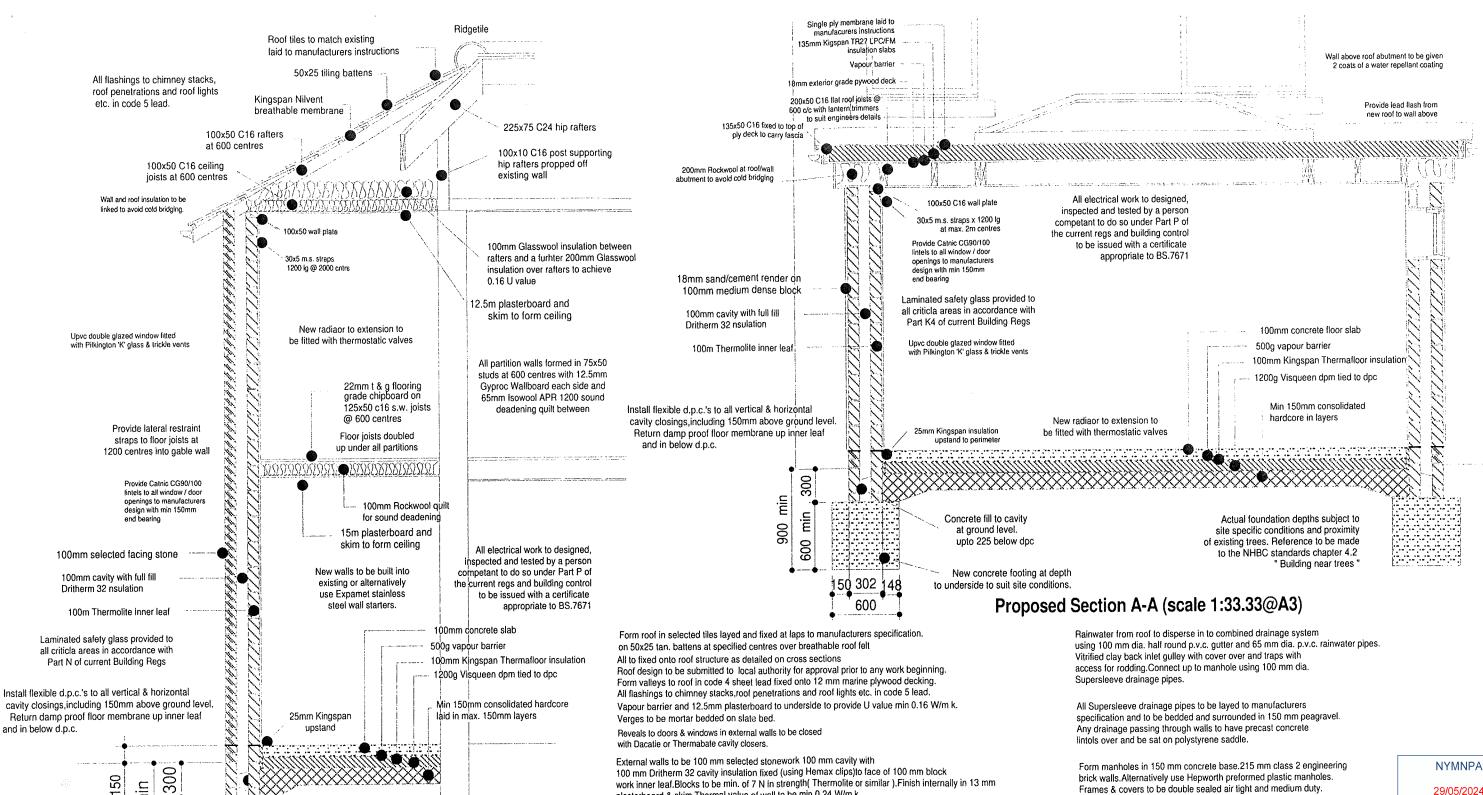

All double galzed windows to be fitted with trickle vents at least equivalent to 8000mm and have openings at least equivalent to 1/20 of floor area of relevant rooms.

Building near trees

Actual foundation depths subject to

site specific conditions and proximity

to the NHBC standards chapter 4.2

of existing trees. Reference to be made

Ë.

New concrete footing at depth

to underside to suit site conditions

900

600

Glazing to patio doors and all other critical areas to be laminated safety glass. Windows frames to be timber with double glazed units with 16mm air gap and a 'soft' low-E coating or a 12mm gap argon filled and a soft low-E coating.

Form ground floor in 100mm concrete slab on 500g vapour barrier on 100mm Kingspan Thermafloor TF70 insulation boards on 1200g Visqueen damp proof membrane tied to d.p.c. on min. 150mm consolidated hardcore laid in max, 150mm layers (thermal value to be min. 0.22 W/m k.)

Form first floor in 22mm flooring grade chipboard on 120x50 C16 floor joists at 600 centres.

Proposed Section B-B (scale 1:33.33@A3)

Form ceiling below in 15mm plasterboard and skim. Provide 100mm unfaced Rockwool insulation to void for sound deadening. Automatic fire detection system to be mains operated self

contained smoke alarms to BS.5446 part 1 and located as shown. Alarms to have secondary battery supply.

Concrete fill to cavity

at ground level.

upto 225 below dpc

U values for various elements of the dwelling to be : Piched roof with insulation 0.16 at ceiling level 0.26 Walls

0.22 Floors Upvc windows Upvc doors

100 mm Dritherm 32 cavity insulation fixed (using Hemax clips)to face of 100 mm block work inner leaf. Blocks to be min. of 7 N in strength (Thermolite or similar). Finish internally in 13 mm plasterboard & skim. Thermal value of wall to be min 0.24 W/m k.

All structural openings to have Catnic or equal approved combined galv. lintol over. Provide stainless steel vertical twist wall ties at 750 horz. cntrs and 450 vet. cntrs. (300 adjacent to openings.)

All internal load bearing walls to be 100mm thick 7N blockwork with reinforced concrete lintels over all openings.

Joist/rafter ends to be strapped down using min.1200x30x6 galvanised mild steel joist straps plugged and screwed to blockwork. Rafter ends to sit on 100x50 tan. s.w. wall plates. Install insulated Catnic or equal approved combined cavity lintols over all cavity wall openings.

Form new concrete foundations. Bottom of founds to be a minimum of 900 below ground level and below inverts of any adjacent drainage. Foundations to be subject to land survey and site conditions (ie adjacent trees)

pipes, connected to manholes.

Connect all W.H. basins, sink units, shower units and baths up to 100 mm dia. p.v.c. soil vent pipes using 50 mm dia p.v.c. waste pipes and anti-siphon traps Connect all W.C.'s and bidets up to the soil vent pipes using 100 mm dia. p.v.c. waste pipes with 'P' traps. Soil vent pipes to be connected up to roof lead flashings. and carried 500 mm through roof. Provide cowel to top of s.v.p. Connect s.v.p. at ground level to 100mm dia p.v.c swept bend pipe and 100 mm dia. p.v.c. drainage

brick walls. Alternatively use Hepworth preformed plastic manholes. Frames & covers to be double sealed air tight and medium duty. Inverts to be determined on site and approved by building inspector prior to laying of drainage.

29/05/2024

ROBUST CONSTRUCTION

Dwelling to be constructed in accordance with the the DEFRA / DTLR " Robust Construction Details " to limit thermal bridging and air leakage.

All switches and socket outlets in habitable rooms to be at heights between 450mm and 1200mm from finished floor level.

Provide a min three per four fixed light fittings which can only be used with energy efficient light bulbs (greater efficiency than 40 lumens per circuit-watt). External lighting to be fitted with dusk to dawn and passive infra red controls and lamp capacity of 150W per light or have sockets which can only be fitted with lamps which have an efficiency greater than 40 limens per circuit-watt.

Sean McLean Design

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PROPOSED DEVELOPMENTS AT 40 IBURNDALE LANE, SLEIGHTS FOR MR & MRS HARRISON

> PROPOSED CROSS SECTIONS AND NOTES

Drg. No. 2183/PL/08 'O' Date APR 21