Amendments/Additional Information

A	mended layout o	f buildings/outside areas			
: : : A	dditional backgro	und information	Robert States (10 grant des de Deuts de Electrica de Co		EDZEDO Nemocialis
A	mended design	- plot 1		. (As #40	odingen Tellaggela. T
R	evised access a	rangements	. Tempel for Mile	and the second	; . :
C	hange of descrip	tion of proposed development		Maria de presentada de la composição de la Composição de la composição de	
C	hange in site bot	ndaries	ing dia Pangana. Panganan		
O	ther (as specified	l below)	ar e da el la las de La la		
		A September of the State	per Elemente Per Elemente Per Elemente	Tarah. Tarah di Karenderak Tarah diput	ur arves est
	. 1,14			**************************************	in the state of th
	12.00				
	St. St.				
	Q-9		: : : :		Francisco (Bertovilei) Francisco
·		The second second		94	
· · · · · · · · · · · · · · · · · · ·				ia roden decembo	
		tina (searche dellad		si kilota Perturbissi Perenang Delembigsi	
				;	· · · · · · · · · · · · · · · · · · ·
	₩1,.			maka Elang Balay	

Wendy Strangeway

From:

Hilary Saunders

Sent:

11 May 2016 09:46

To:

Planning

Subject:

FW: Coach Road Development, Sleights by Gray and Sons.

Attachments:

D10612-22G.pdf; D10612-23B.pdf; D10612-24A.pdf; D10612-17B.pdf

H. Saundes

Mrs Hilary Saunders
Planning Team Leader
Development Management

North York Moors National Park Authority
The Old Vicarage
Bondgate
Helmsley
York
YO62 5BP

Tel. no. 01439 772700

Web: www.northyorkmoors.org.uk

From: Tim Harrison (BHD) **Sent:** 11 May 2016 09:18

To: Hilary Saunders

Subject: Coach Road Development, Sleights by Gray and Sons.

Dear Hilary,

With regard to the above development and your request for a revised drawing to show the detached house at the entrance to the site we provided Colin Gray with copies of this drawing last week and we know that he prefers to have a paper copy for himself and to deliver or post a paper copy to you.


However we did feel that you may also like to have an electronic copy for your file and therefore this is attached for your attention and consideration.

We have also attached copies of the recently revised Highways Drawings sent to Colin which he will be discussing with Ged Lyth at NYCC Highways after months of Colin's previous discussions and negotiation with Ged.

We trust that this information will be helpful and if your require any further technical information please do not hesitate to contact us.

Kind Regards

Tim Harrison

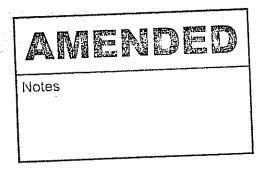


NYMNPA

1 1 MAY 2016

0

Typical cross-section through points G and H

Scale: 1:50 @ A3

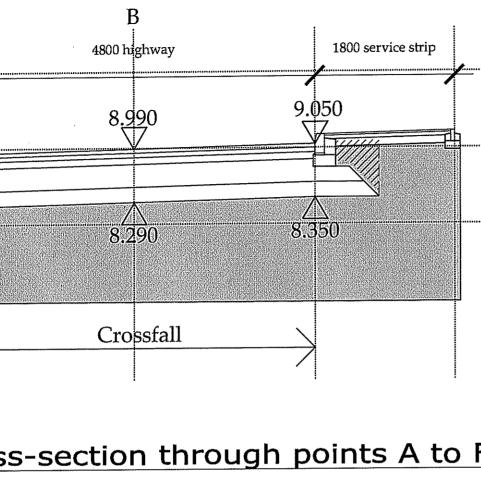

Typical cross-section through points A to F

Scale: 1:50 @ A3

Road Specification - Total depth 700mm.

- Capping layer of stone 200mm thick. DOT Type 1 sub-base - 300mm thick.
- Roadbase tarmac 90mm thick.
- Base centre tarmac 60mm thick.
- Wearing course tarmac 50mm thick.

Service Strip Specification

10.00

9.00

8.00

8.930

8.230

- 20mm Dense Wearing Course
- 50mm Dense Base Course
- 150mm Type 1 Sub Base

Alternative Service Strip Specification

- 80mm thick concrete block pavers
- 50mm sand
- 150mm Type 1 Sub Base

Road Specification

- Capping layer to be well-graded crushed rock. All material to pass through 125mm BS. sieve but max 12% to pass 63 micron sieve and well compacted.
- DOT Type 1 sub-base to be well-graded crushed rock and well-compacted within the limits defined in NYCC materials specification 4.04. Granular sub base material. All materials and depths are based on a CBR above 2%
- Located macadam for carriageways are to consist of materials to conform to BS 4987 Part 1.
- Roadbase material to BS. Clause 5.2 28mm nominal size dense roadbase using 100pen binder giving a compacted thickness of 90mm.
- Base course material to BS. Clause 6.5, 20mm nominal size dense basecourse using a 100 pen bitumen binder giving a compacted thickness of 60mm.
- Wearing course material to BS. Clause 7.3, 14mm nominal size close graded wearing course using 100 pen bitumen binder giving a compacted thickness of 50mm.

Note: Limestone aggregate wall shall not be used in coated macadam materials.

partnership

Airy Hill Manor, Whitby, North Yorkshire, UK, YO21 1QB.

OO NOT SCALE from this drawing. Only figured dimensions are to be taken from this drawing.

The Contractor must verify all dimensions on site before commending any work or shop drawings. The Contractor must report any discrepancies before

mmencing work. If this drawing exceeds the quantities


Work within The Construction (Design and Management) Regulations 1994 is not to start until a Health & Safety Plan has been produced. This drawing is Copyright and must not be reproduced without consent of BHD


						CLIEN	-	Sons				
						PROJE		West	· of			
В	10.05.16	CW	Amended to suit NYCC			Land to West of Coach Road, Sleights					r	
A	19,01,16	CW	Issued for approval	TRH		A3	DRN:	C Wal	ker	DATE:	19.01.16	l
REV	DATE	BY	AMENDMENT	CHKD	APVD	SCALE:	1:50	@ A3	ISSUE	: Co	nstruction	L

DRAWING TITLE:


Proposed sections through lettered points on proposed adoptable road

DRAWING NR: D10612-23 REV: \mathbf{B} חתם

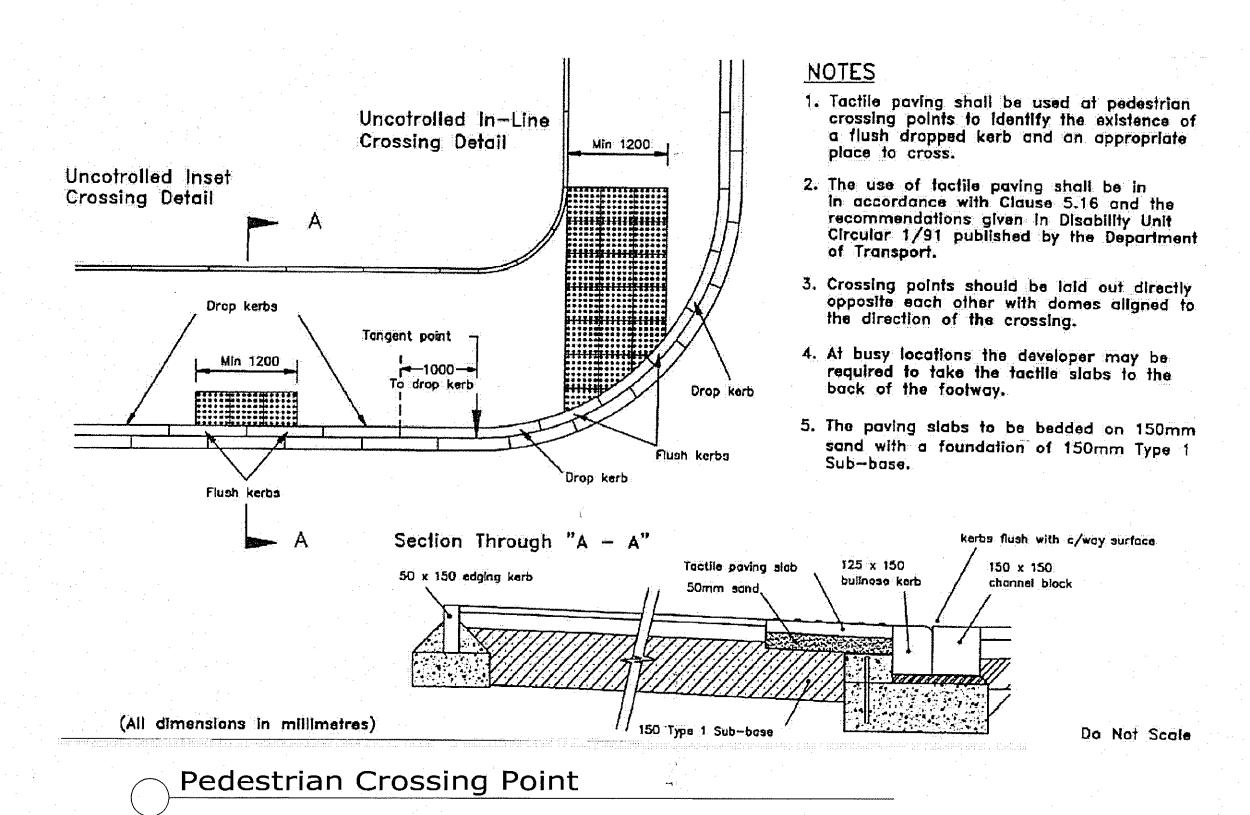


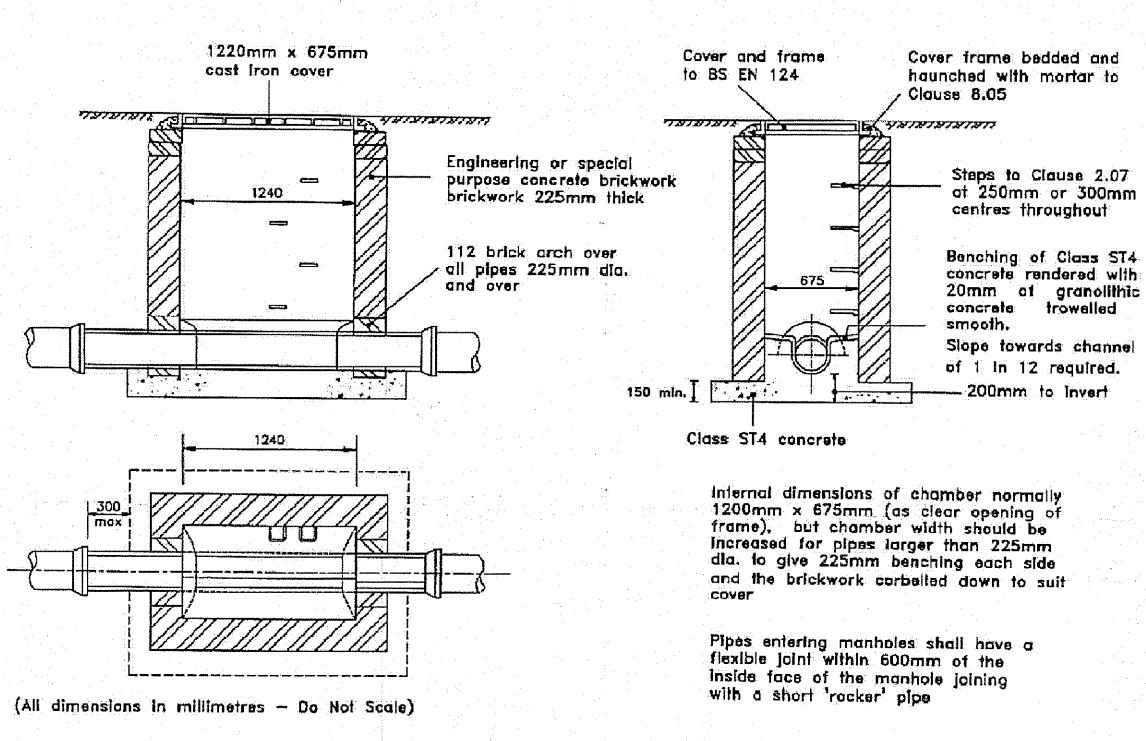

Drainage - Brick manhole (1.0m to 1.5m)

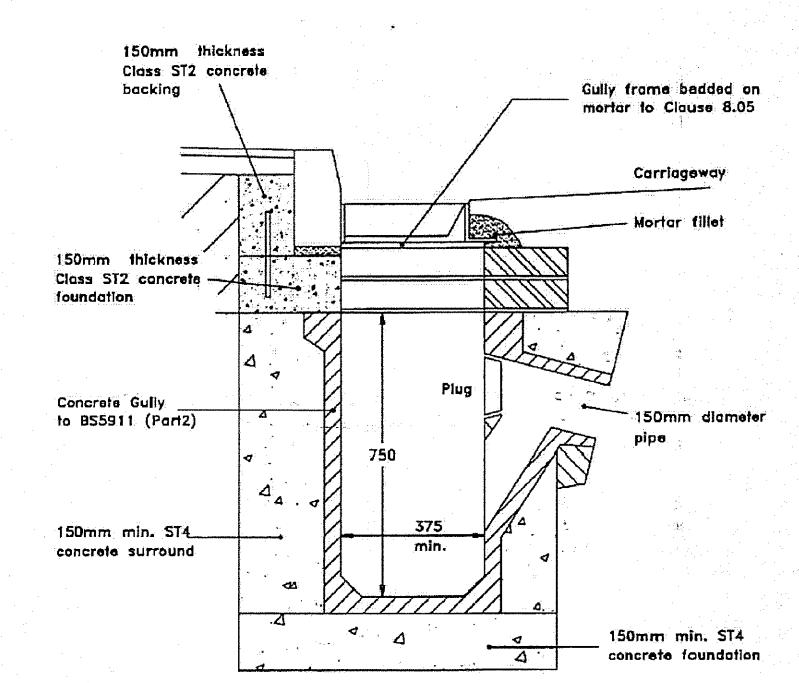

Precast Concrete Road Gully

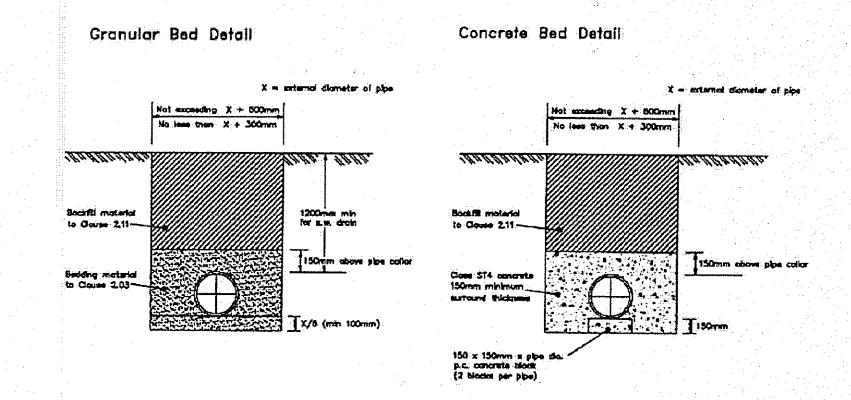

- Trenches shall be excavated in accordance either Clause 2.07.
 Unless otherwise approved by the Engineer, all surface water
 pipes shall have a minimum cover of 1.2 metres from the
 finished surface.
- 2. Immediately following the excavation of the trench the pipes shall be laid and jointed on the pipe bed. The bedding, laying and surrounding of pipes shall be in accordance with Clause 2.08. Except where a concrete bed and surround is specified pipe bedding and surround materials shall be a granular material, natural crushed gravel or rock, in accordance with Clause 2.03.
- 3. Backfilling of trenches shall, wherever practicable, be undertaken immediately pipe laying operations have been completed in accordance with Clause 2.11. Sub soil drain trenches shall be backfilled with Type B Filter Material as specified under Clause 2.04. Trenches within the adoptable highway shall be backfilled with Type 1 Sub—base material as Clause 4.04. Trenches outside the adoptable highway shall be backfilled with selected excavated material approved by the Engineer where it is at a moisture content near to the optimum moisture content or with Type 1 Sub—base to Clause 4.04.

Do Not Scale


Bedding details for surface water and sub-soil drains

Do not scale from this drawing. only figured dimensions are to be taken from this drawing.

The contractor must verify all dimensions on site before commencing any work or shop drawings.

The contractor must report any discrepancies before commencing work. If this drawing exceeds the quantities taken in any way, the technician is to be informed before work is initiated.

Work within the construction (design and management) regulations 1994 is not to start until a health & safety plan has been produced. This drawing is copyright and must not be reproduced without consent of BHD Partnership Ltd.

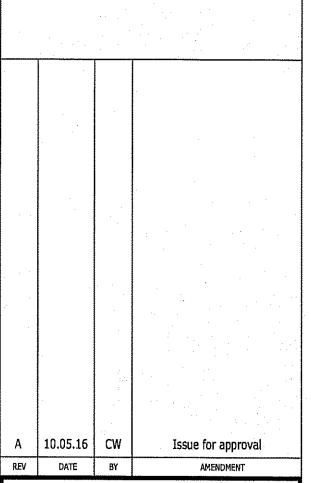

ond partnership

Architecture + Engineering

Alry Hill Manor, Waterstead Lane, Whitby, N. Yorks. YO21 1QB.

Gray & Sons

.

Land to West of Coach Rd, Sleights

Drawing:

Highways and Drainage Details

DRAWING STATUS:

Preliminary

DRAWN:

C Walker

T.Harrison


SCALE @ SIZE:

N/A

10.05.16

D10612-24

)612-24

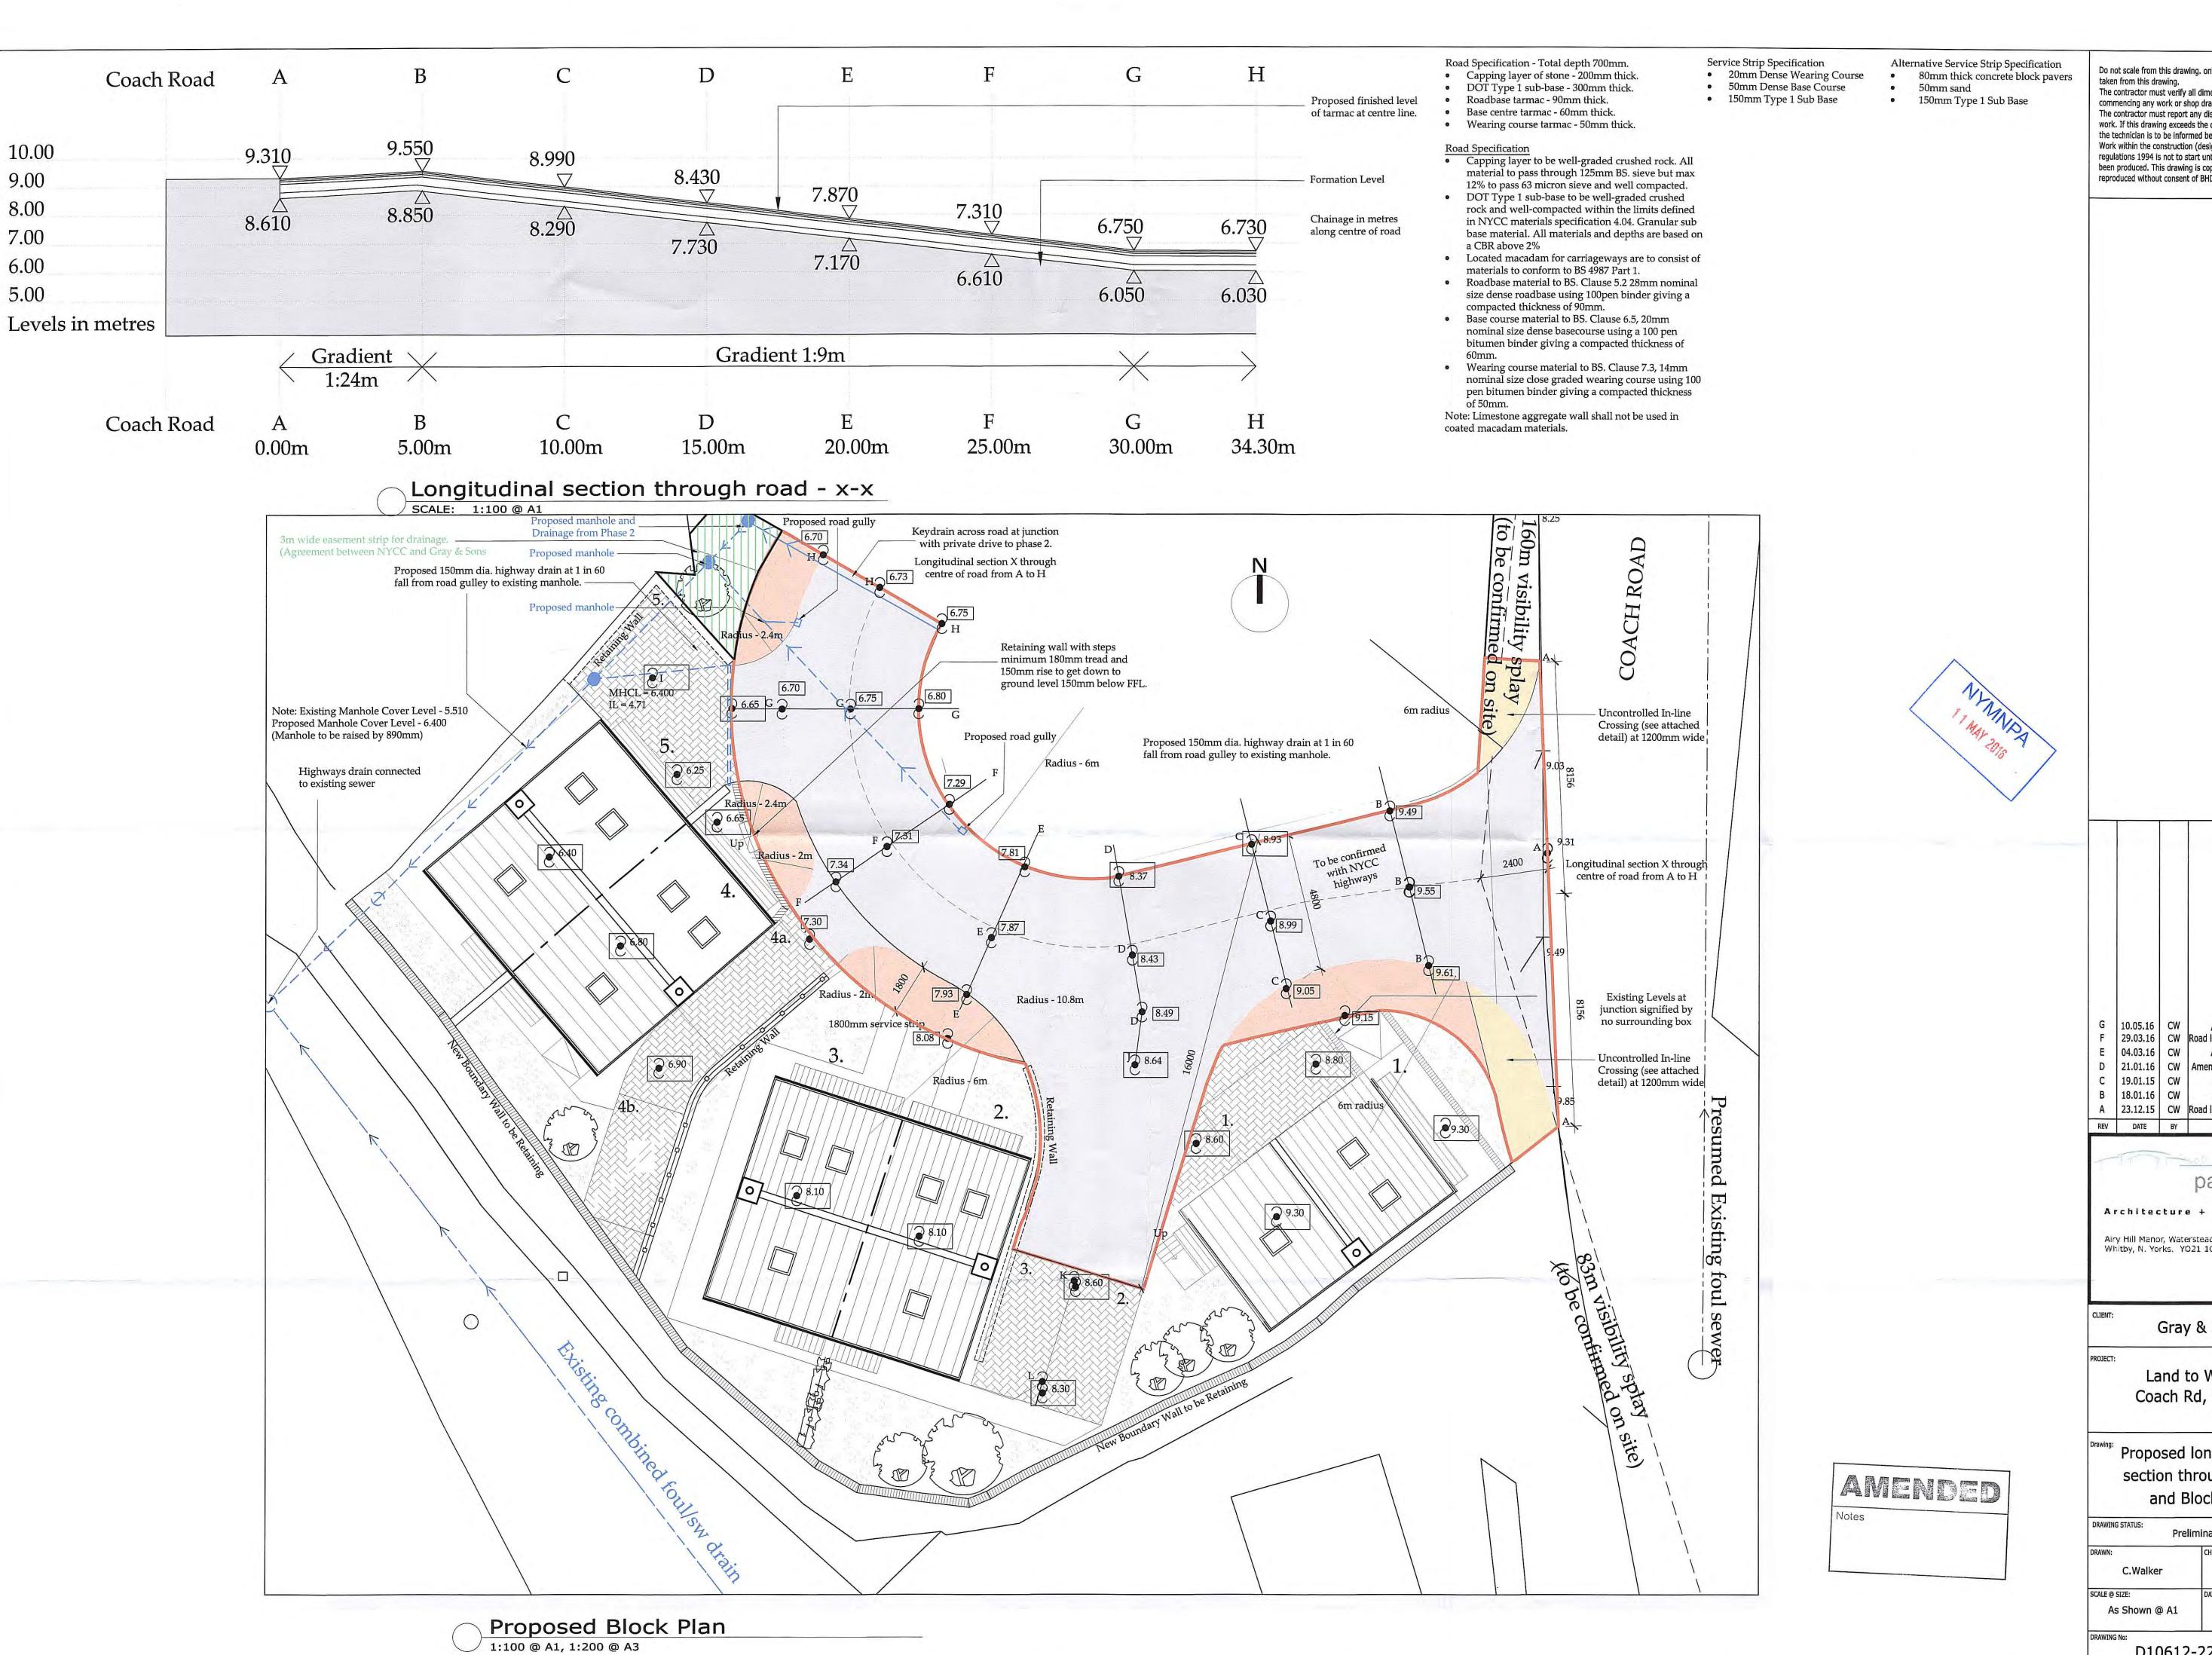

Do not scale from this drawing, only figured dimensions are to be The contractor must verify all dimensions on site before

commencing any work or shop drawings. The contractor must report any discrepancies before commencing work. If this drawing exceeds the quantities taken in any way, the technician is to be informed before work is initiated. Work within the construction (design and management) regulations 1994 is not to start until a health & safety plan has been produced. This drawing is copyright and must not be reproduced without consent of BHD Partnership Ltd.

G 10.05.16 CW Amended to suit NYCC F 29.03.16 CW Road levels amended to suit client E 04.03.16 CW Amended to suit client D 21.01.16 CW Amended to suit NYCC Highways
C 19.01.15 CW Road levels amended
B 18.01.16 CW Prop. levels amended A 23.12.15 CW Road levels amended to suit client

partnership Architecture + Engineering

Airy Hill Manor, Waterstead Lane, Whitby, N. Yorks. YO21 1QB.

Gray & Sons

Land to West of Coach Rd, Sleights


Proposed longitudinal section through road and Block Plan

T.Harrison 23.12.15

D10612-22

G



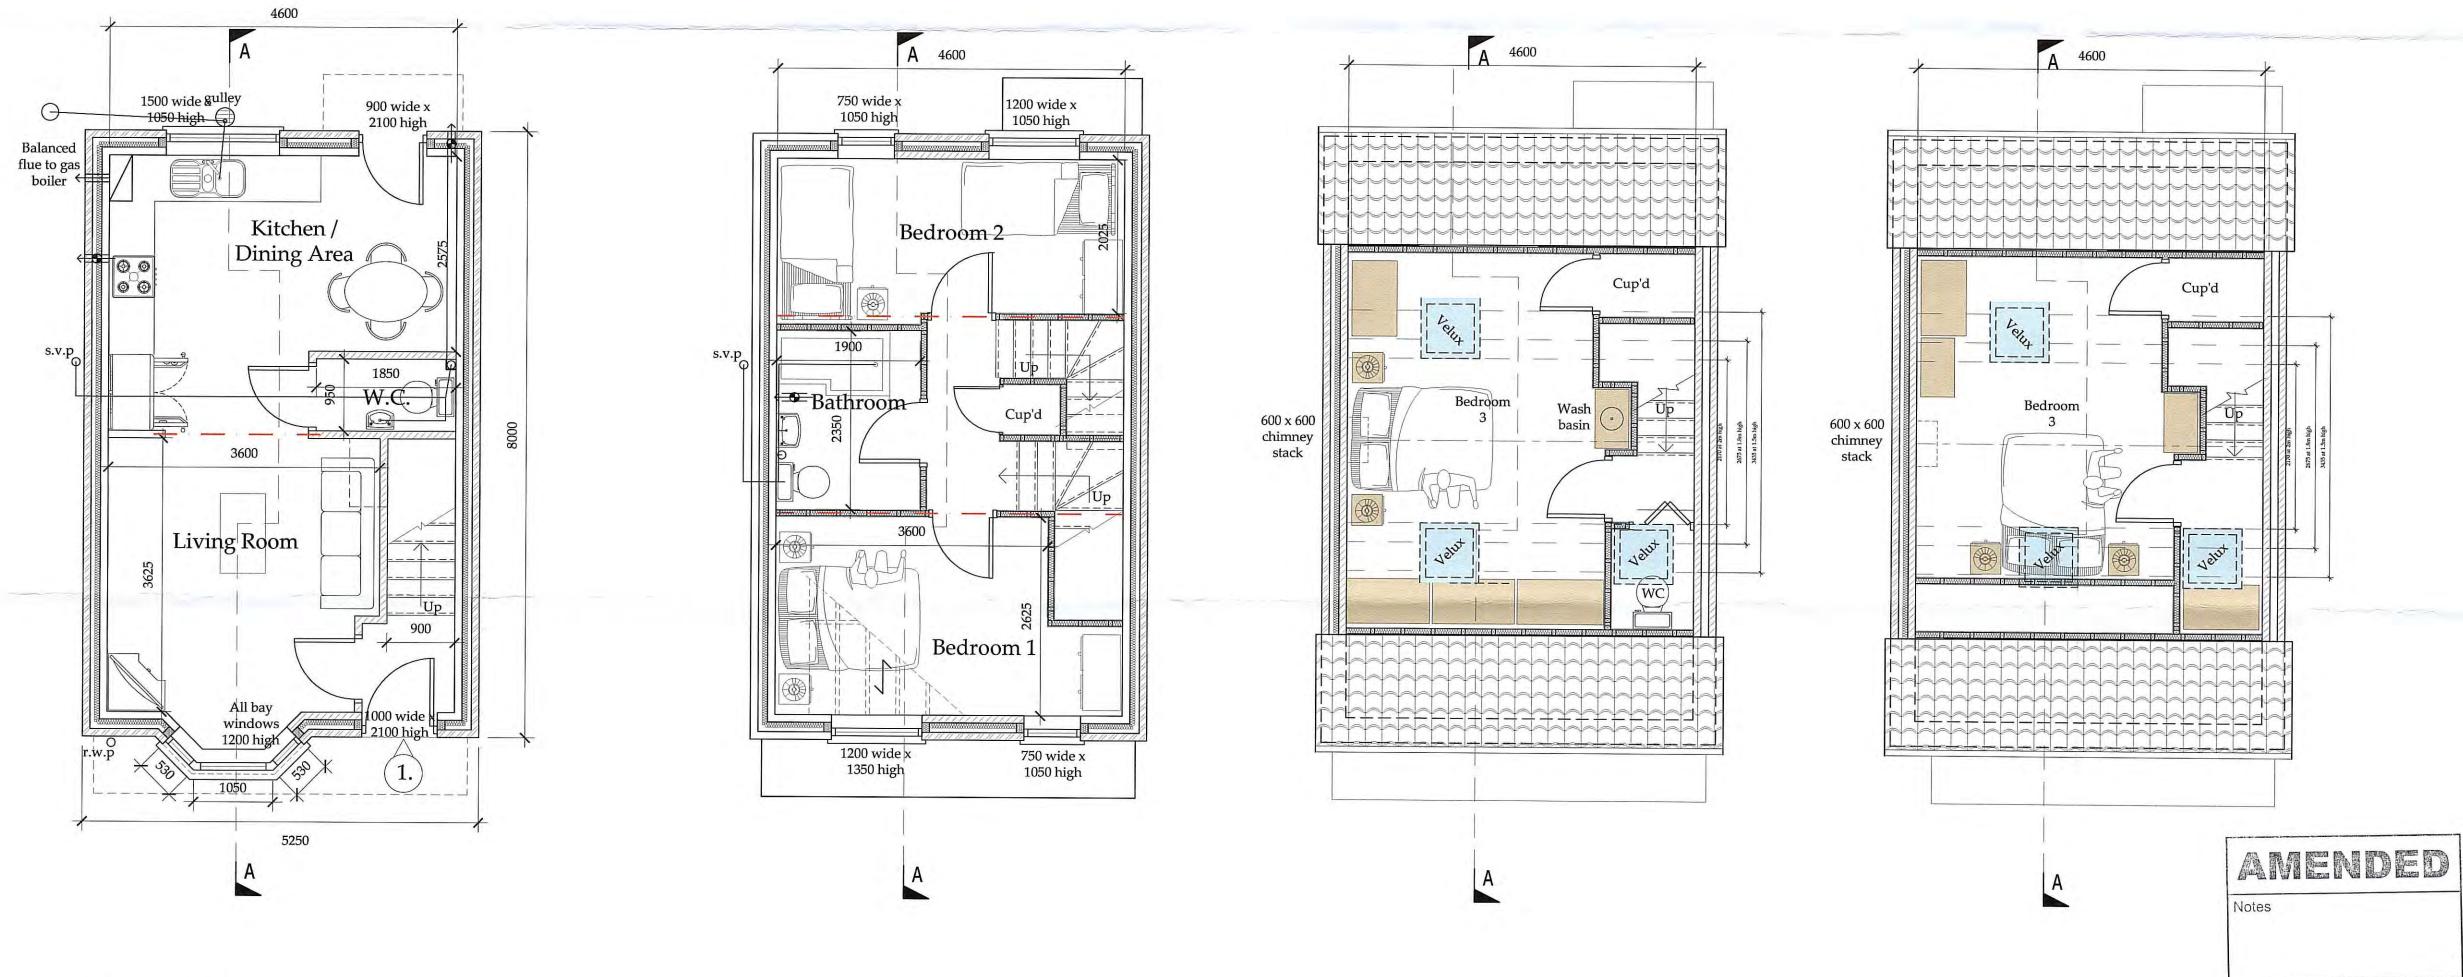

Second Floor Plan

SCALE: 1:50

First Floor Plan

Ground Floor Plan

Do not scale from this drawing. only figured dimensions are to be taken from this drawing.

The contractor must verify all dimensions on site before commencing any work or shop drawings.

The contractor must report any discrepancies before commencing work. If this drawing exceeds the quantities taken in any way, the technician is to be informed before work is initiated.

Work within the construction (design and management) regulations 1994 is not to start until a health & safety plan has been produced. This drawing is copyright and must not be reproduced without consent of BHD Partnership Ltd.



NOTE:
All windows to be White coloured uPVC or to suit Planning Authority

B 06.05.16 CW Amended to suit client
A 23.12.15 CW Issue for approval
REV DATE BY AMENDMENT

Architecture + Engineering

Airy Hill Manor, Waterstead Lane, Whitby, N. Yorks. YO21 1QB.

Gray & Sons

T:

Land to West of Coach Rd, Sleights

Proposed Plans & Elevations
For New Detached House

DRAWING STATUS:

Preliminary

CHECKED:

D.Cairns

T.Harrison

SCALE @ SIZE:

As Shown @ A1

DRAWING No:

REV:

D10612-21

B

Alternative Second Floor Plan

SCALE: 1:50