

SOUTH ELEVATION

N O R T H E L E V A T I O N

NYMNPA

16/04/2018

Proposed:


ALTERATIONS to YORK HOUSE KING STREET ROBIN HOODS BAY

Drawing: EXISTING ELEVATIONS I

Drawing No. 193/03 Date: DECEMBER 2017 Scale: 1/50

MICHAEL MILLER BA(Hons) ARCH. CIAT Architectural Consultant.



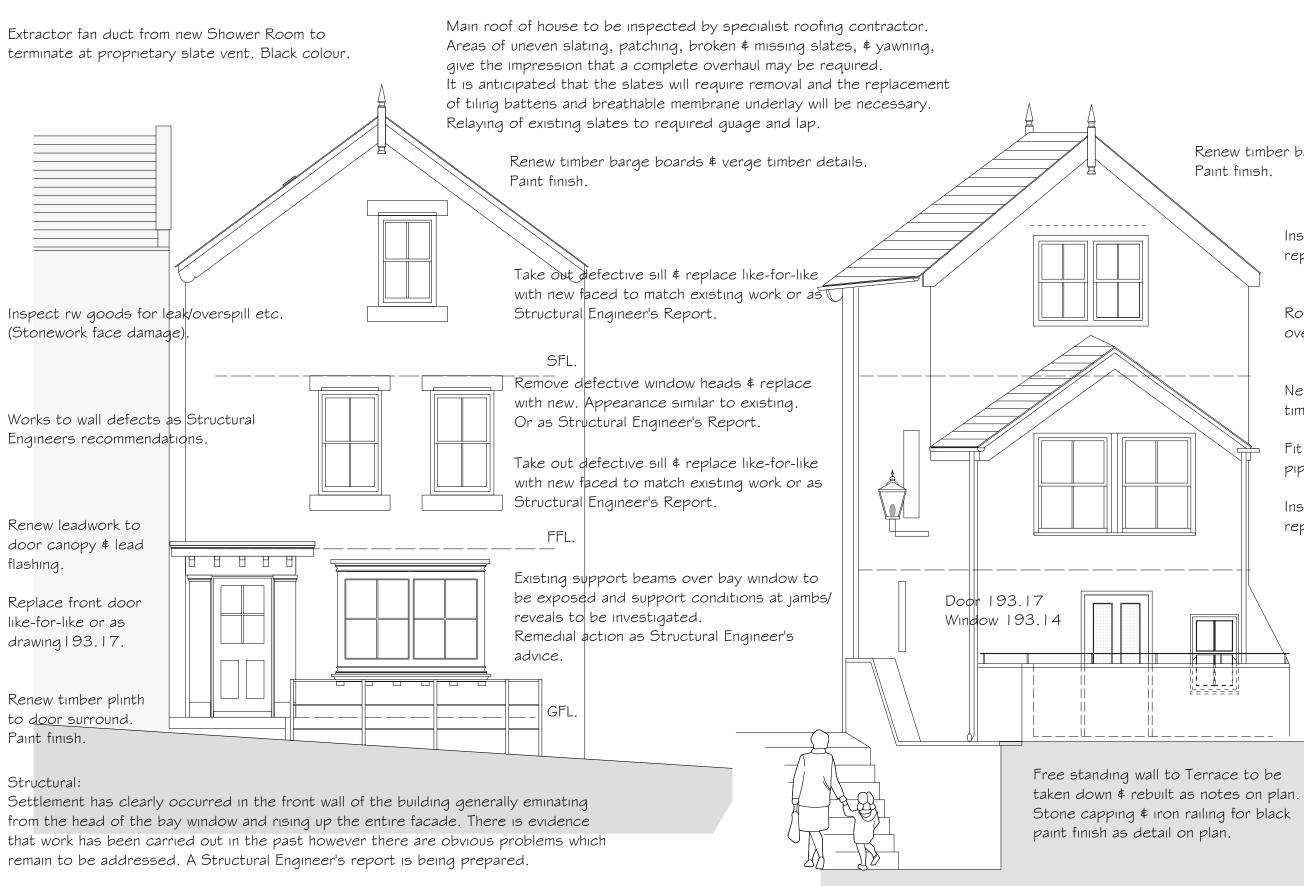

OUTH ELEVATION S

ELEVATION ORTH Ν

Renew timber barge boards \$ verge timber details. Paint finish.

Inspect timber to window frame \$ repair as required. Paint finish.

Roof to first floor extension to be overhauled as notes on plan drawing.

New timber barge boards & verge timber details. Paint finish.

Fit return to rw gutter \$ 50mm fall pipe. Discharge to current location.

Inspect timber to window frame \$ repair as neccesary. Paint finish.

Proposed:


ALTERATIONS to YORK HOUSE KING STREET ROBIN HOODS BAY

Drawing: EXISTING ELEVATIONS I

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EAST ELEVATION

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16/04/2018

Proposed:

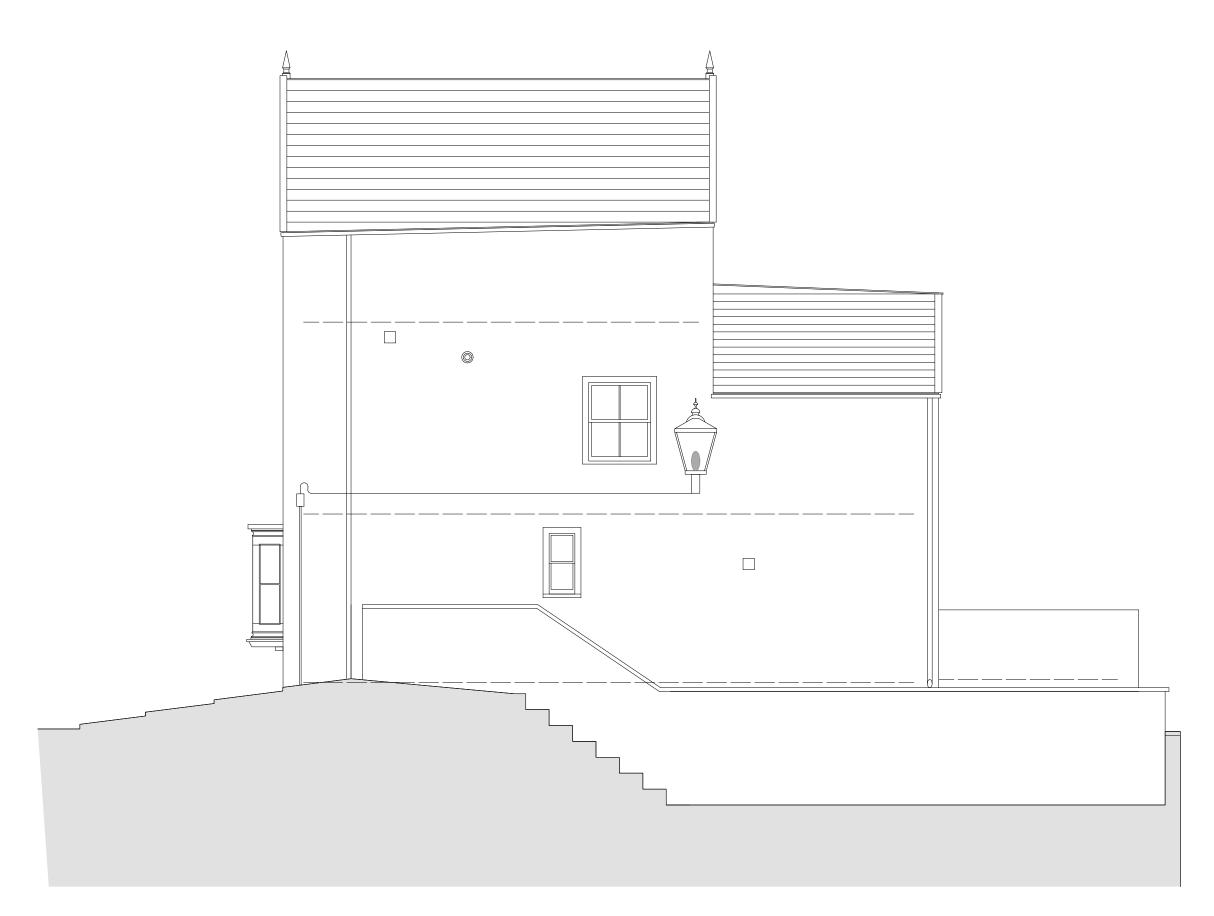ALTERATIONS to YORK HOUSE KING STREET ROBIN HOODS BAY

Drawing: EXISTING SIDE (EAST) ELEVATION

Drawing No. 193/04 Date: DECEMBER 2017 Scale: 1/50

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Main roof of house to be inspected by specialist roofing contractor. Areas of uneven slating, patching, broken \$ missing slates, \$ yawning, give the impression that a complete overhaul may be required. It is anticipated that the slates will require removal and the replacement of tiling battens and breathable membrane underlay will be necessary. Relaying of existing slates to required guage and lap.

Renew timber barge boards \$ verge timber details. Paint finish.


Roof abutment with Second Floor Level wall: remove timber batten detail \$ reinstate using lead flashing \$ soakers to slating. Adjust/reinstate render

extension.

Lay breathable membrane. New treated sw battens. Re-lay slates to correct gauge \$ lap for size \$ location. Fix with copper nails. Renew timber barge boards/plates \$ slate cover battens to match existing.

Take down rainwater goods. clean & repaint.

Take down extg wall to terrace \$ reconstruct in reclaimed stonework coursing and bonding to match better construction elsewhere. Finish top with sawn stone capping to match adjacent work. Wrought iron railing to wall top to form total ht of structure to 1.10m

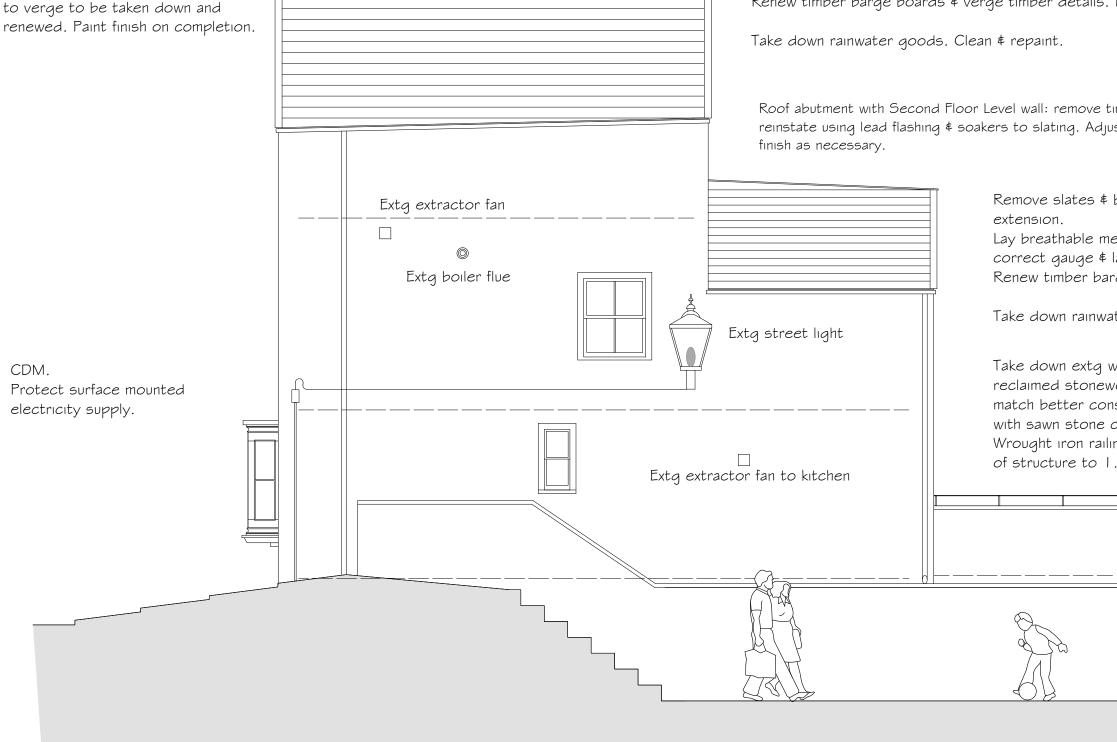

EAST ELEVATION

Barge boards \$ other timber trims

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Remove slates \$ battens from existing roof over First Floor level

Proposed:

ALTERATIONS to YORK HOUSE KING STREET ROBIN HOODS BAY

Drawing: PROPOSED SIDE (EAST) ELEVATION

Drawing No. 193/13 Date: JANUARY 2018 Scale: 1/50

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G

PRINT TO A3



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Proposed:


ALTERATIONS to YORK HOUSE KING STREET ROBIN HOODS BAY

Drawing: EXISTING GROUND FLOOR PLANS

Drawing No. 193/01 Date: DECEMBER 2017 Scale: 1/50

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IRST FLOOR F

SEGOND FLOOR
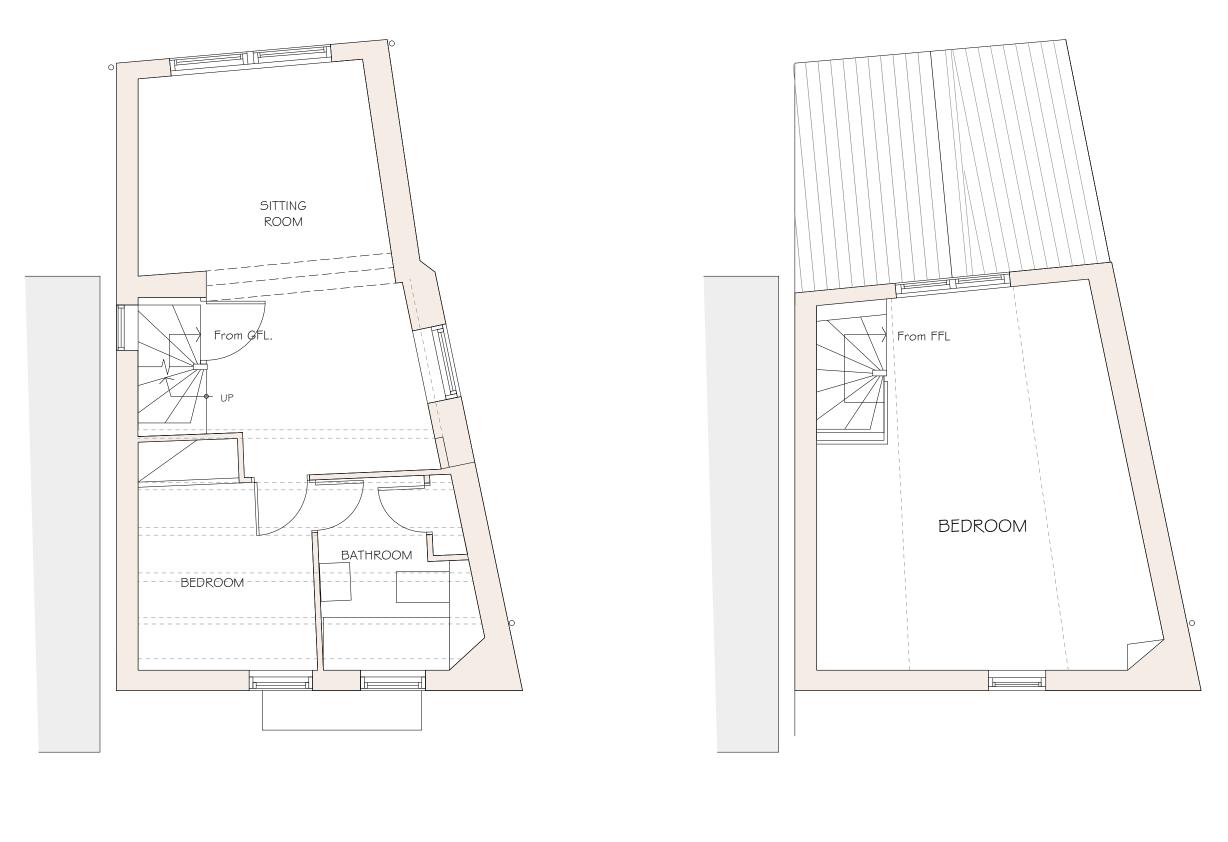
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Proposed:

ALTERATIONS to YORK HOUSE KING STREET ROBIN HOODS BAY

Drawing: EXISTING FIRST FLOOR & SECOND FLOOR PLANS

Drawing No. 193/02 Date: DECEMBER 2017 Scale: 1/50

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Wrought iron railing approx 200mm height on sawn stone coping on stone wall. O/a height from deck | | OOmm. See Section opposite. TERRACE Take out existing standsheet window frame \$ replace with vertical sliding timber sash window as detail 193.14. All Kitchen area and Hallway thro' to front door: floor to be finished with laminate floor covering as client directs. KITCHEN Central Heating system to be flushed using specialist machinery DINING \$ system serviced on completion 0of radiator additions and system alterations. Timber door to Kitchen/Hall to be replaced with new door like-for-like. 11/2 prs brass butt hinges \$ handle/latch as client directs. SHOWER Existing Washing machine & tumble dryer under staircase. Heating radiator to bedroom to be relocated and size adjusted as req'd. HALL BEDROOM Front door approx 765 x 1810mm \$ frame to be replaced as detail 193.17. Replace plinth to door opening embrasure. Make good/replace lead flashing to entrance door embrasure. footway KING STREET

Take down stone wall to terrace \$ rebuild in coursed stonework min 215mm thick on bed. BRE Good Building Guide No. 14. Max height 1075mm.

Coursing & face to match better examples locally. Render finish to internal face to be white colourwash. Sawn stone capping as neighbouring property & wrought iron railing approx 200mm height to form guard rail o/a 1100mm. CDM Working at height.

Remove rear door approx 870 x 1775mm \$ frame \$ fit new as detail 193.17.

2

3

4

5

6

7

4

3

2

Repair match board panelling under window opening. Repair defective plasterwork to wall panel rhs window opening.

Take down section of ceiling where defective in order to ascertain cause of ingress of moisture. Carry out remedial works \$ reinstate ceiling on completion.

Remove existing kitchen units. Install new Kitchen base units and wall units to client's specification. Allow for connection of appliances to services. Sink. Dish washer. Fridge. Swithed socket outlets as Client directs.

0

External steps shown for information.

Existing electrical sytem tested 2017 advised by client. New/alterations to be carried out by certified contractor.

Fire Detection and Alarm.

Fire Detection and Alarm system installed to recommendations of BS 5839-6:2004 to at least a Grade D category LD3 standard. Client advises this is the current system.

Remove corner cupboard to Bedroom (this is not historic fabric). Construct new cupboard to conceal vertical risers/circulation pipes \$ gas meter.

Remove modern matchboard lining to head of bay window to expose
 existing structural support. Inspect and carryout remedial work on a
 like-for-like replacement basis.


Overhaul lead sheet covering to Bay Window & fit new lead flashing as necessary.

(NB. Presently ingress of water at head location)

(External wall variously cracked/settled above this location).

PRINT TO A3



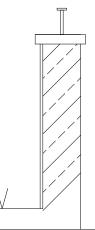

10 x 50mm ms. top plate.
16mm dia ms. posts @ approx
900mm centres. Galvanised \$
black paint finish.
215mm on bed stonework.
Lime mortar bed \$ pointing.
Lime render face internally.
Silicate paint colour coat.

Floor level.

Sea Wall

SECTION THRO' TERRACE WALL 1:20

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Proposed:

ALTERATIONS to YORK HOUSE KING STREET ROBIN HOODS BAY

Drawing: PROPOSED GROUND FLOOR PLANS

Drawing No. 193/10 Date: JANUARY 2018 Scale: 1/50

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Inspect timber external surround to window opening *treplace on a like-for-like basis. Prime timber* I x undercoat prior to fixing paint finish.

T


S

F

R

F


CDM reduce work at height.

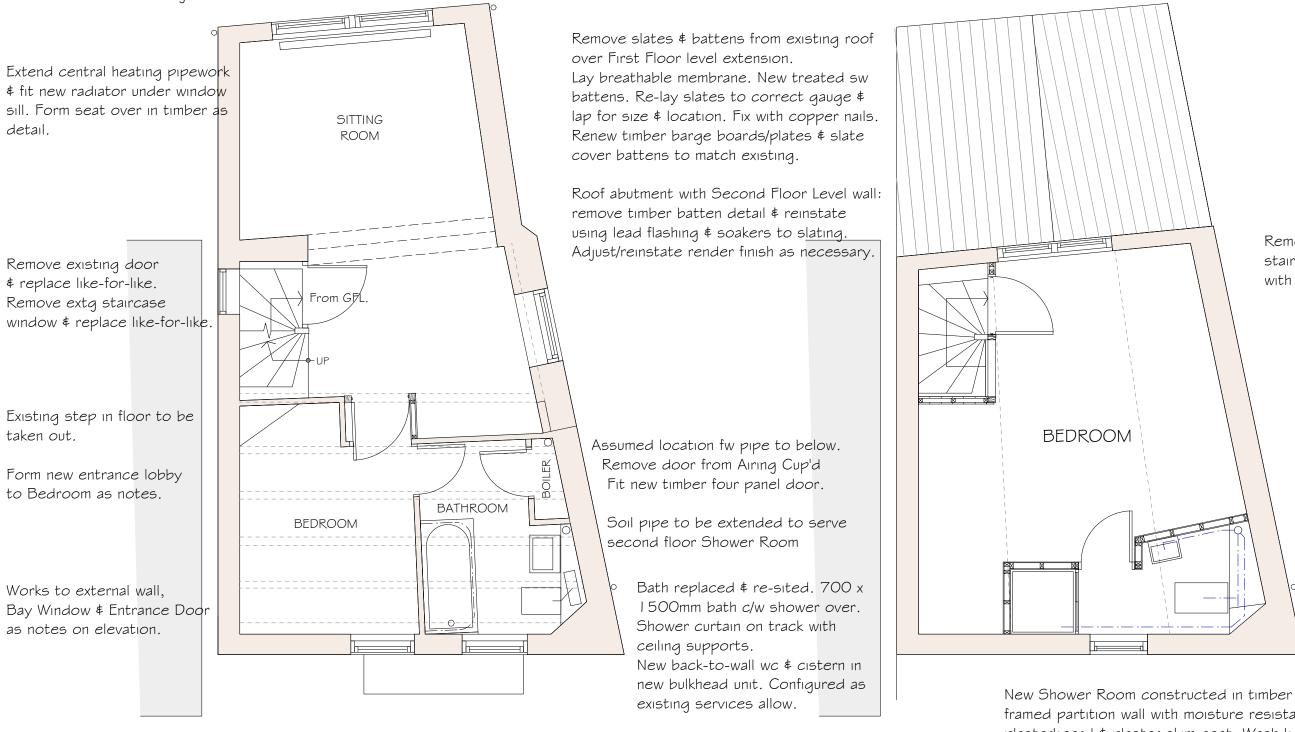

framed partition wall with moisture resistant plasterboard & plaster skim coat. Wash basin, wc \$ shower unit (tray/screen/wall panels/mixer \$ spray) as client directs. Floor finish as client. Layout assumes that tray is on riser kit \$ waste in duct to s/vp \$ drop to connection in boiler cupboard below.

F

D)

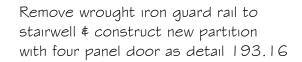

Prepare existing boards to flank walls for repainting.

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Proposed:

ALTERATIONS to YORK HOUSE KING STREET ROBIN HOODS BAY

Drawing: PROPOSED FIRST FLOOR & SECOND FLOOR PLANS

Drawing No. 193/11 Date: JANUARY 2018 Scale: 1/50


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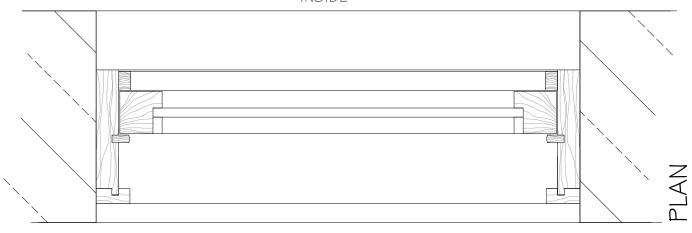









INSIDE

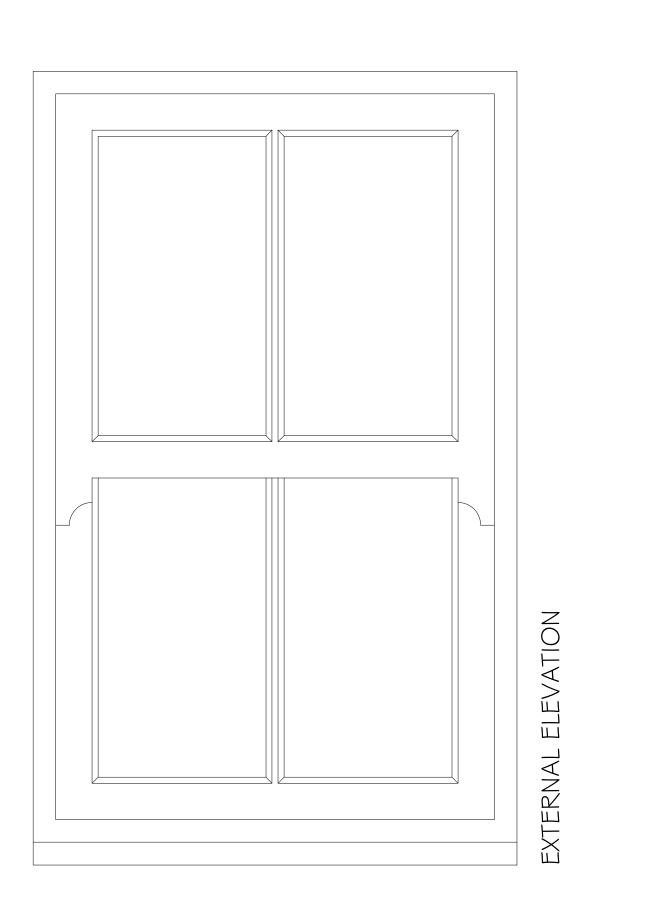

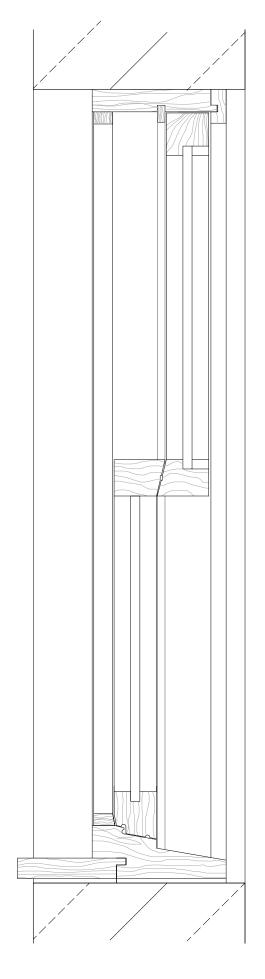

Proposed:

ALTERATIONS to YORK HOUSE KING STREET ROBIN HOODS BAY

Drawing: PROPOSED

OUTSIDE

CONSTRUCTION:

Vertical sliding sash window frame to be constructed in accoya for white paint finish. Timber sections as manufacturers standard sections and spring balance mechanism rebated into sash frame as Wonder of Wood Limited details. I 2mm Slimlite double glazed unit. Toughened glass both panes. Inner pane Low-E. Argon filled cavity. Glazing as Slimlite details

KITCHEN WINDOW FRAME

SECTION

Drawing No. 193/14 Date: FEBRUARY 2018 Scale: 1/10

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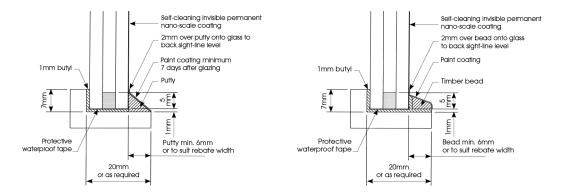
16 PARK VIEW. GLAISDALE. WHITBY NORTH YORKSHIRE. YO21 2PP.


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slimlite glazed with putty & butyl

slimlite glazed with beads & butyl






ELEVATION to SIDE. FACING into STAIRWELL

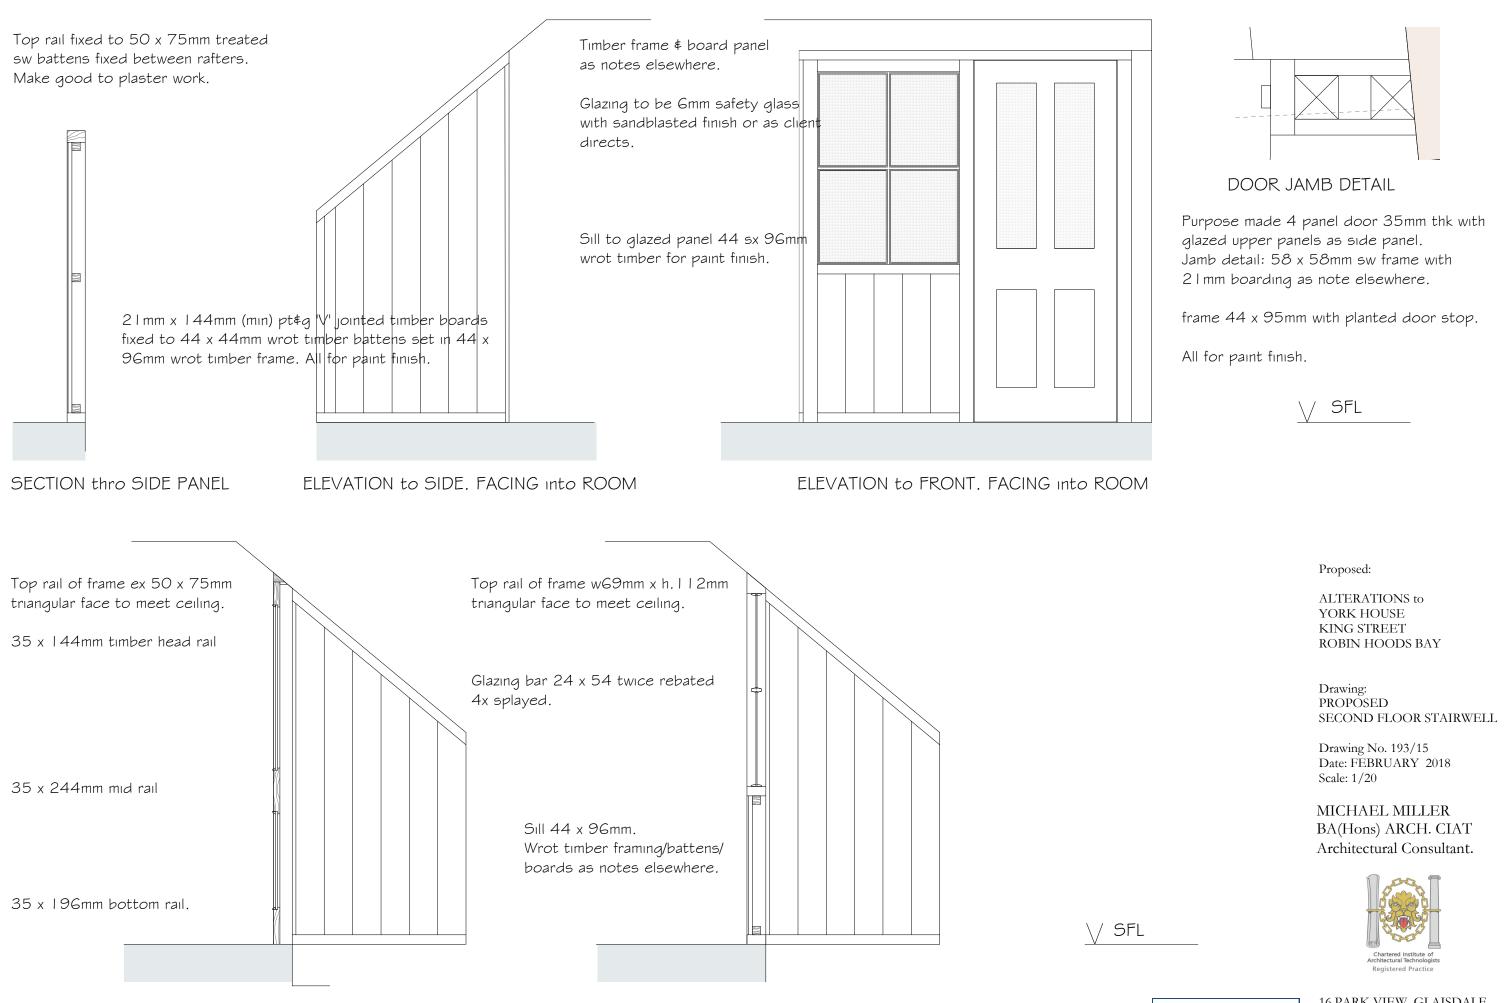ELEVATION to SIDE. FACING into STAIRWELL **♯** GLAZED SECTION.

16 PARK VIEW. GLAISDALE. WHITBY NORTH YORKSHIRE. YO21 2PP.

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DOOR SECTION

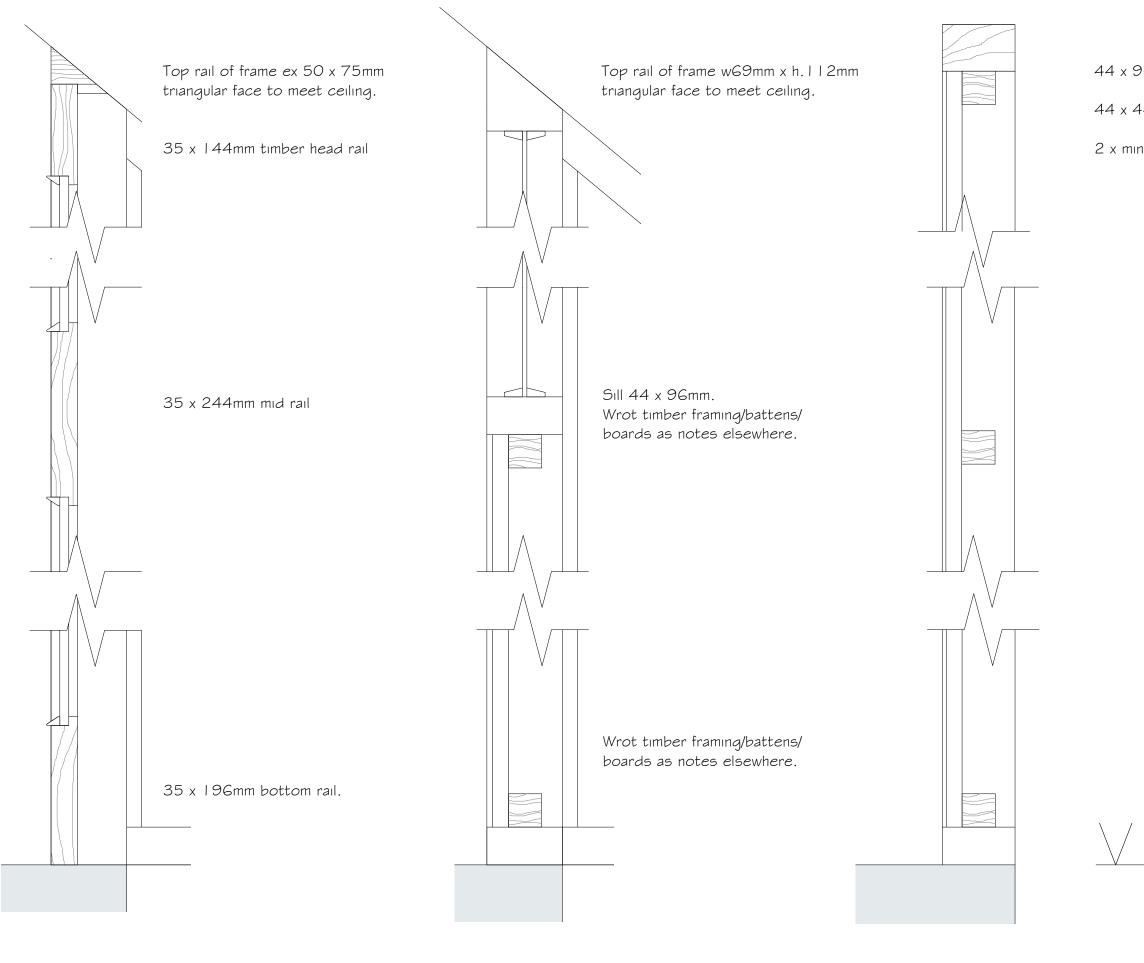GLAZED SECTION

SIDE PANEL

44 x 96mm wrot timber framework

44 x 44 wrot timber battens

2 x min 144mm pt\$g 'V' jointed boards.

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Proposed:

ALTERATIONS to YORK HOUSE KING STREET ROBIN HOODS BAY

Drawing: PROPOSED SECOND FLOOR STAIRWELL PARTITION SECTIONS.


Drawing No. 193/16 Date: FEBRUARY 2018 Scale: 1/5

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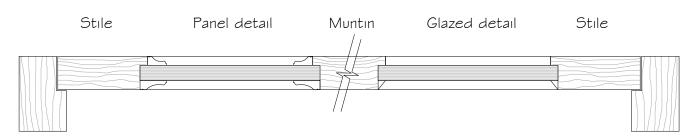
16 PARK VIEW. GLAISDALE. WHITBY NORTH YORKSHIRE. YO21 2PP.

Floor Level



EXTERNAL ELEVATION

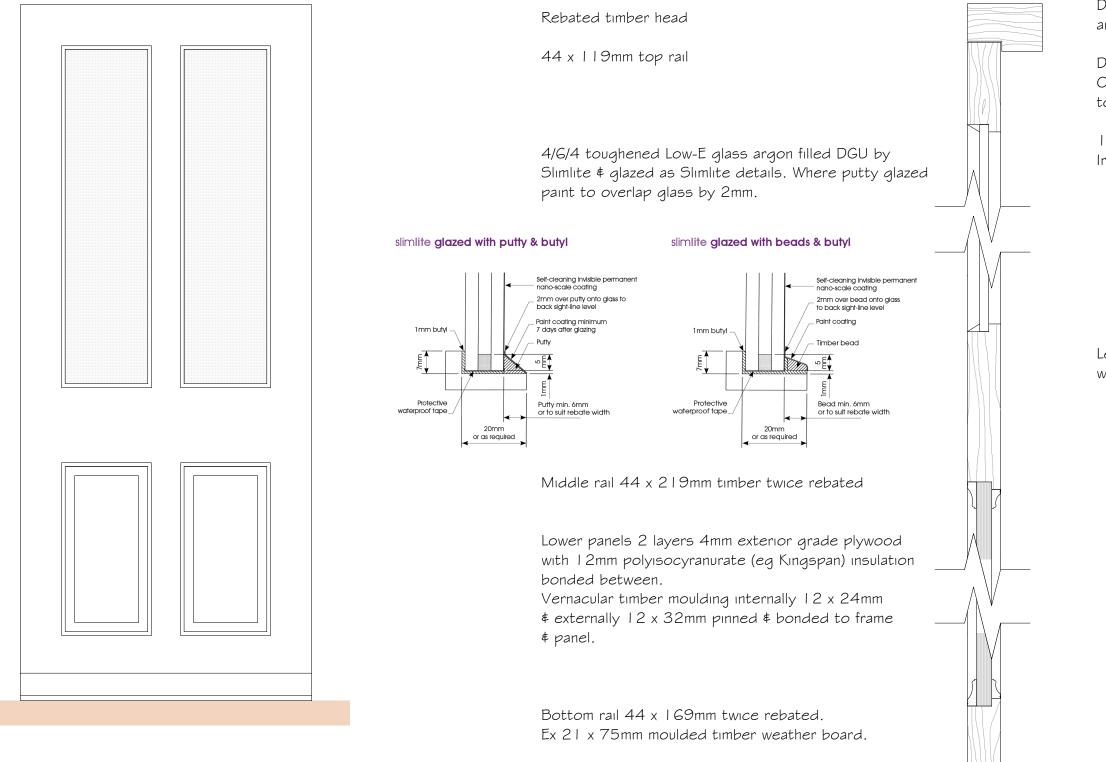Proprietary low sill threshold eg Stormguard Slimline rain & draught excluder.



PLAN

Door details are for a purpose made door and may vary should a standard door be suitable.

Door seals not shown for purposes of clarity. Compressible section flipper seal set in rebate top rail \$ jambs of frame.

11/2 prs 100mm brass butt hinges per door. Ironmongery as client directs.

Letter plate maximum aperature 40mm x 260mm with internal flap.

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Proposed:


ALTERATIONS to YORK HOUSE KING STREET ROBIN HOODS BAY

Drawing: PROPOSED EXTERNAL DOOR.

Drawing No. 193/17 Date: FEBRUARY 2018 Scale: 1:5 & 1:10

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GFL FRONT BEDROOM SERVICE DUCT

SFL ATTIC WC SERVICE DUCT
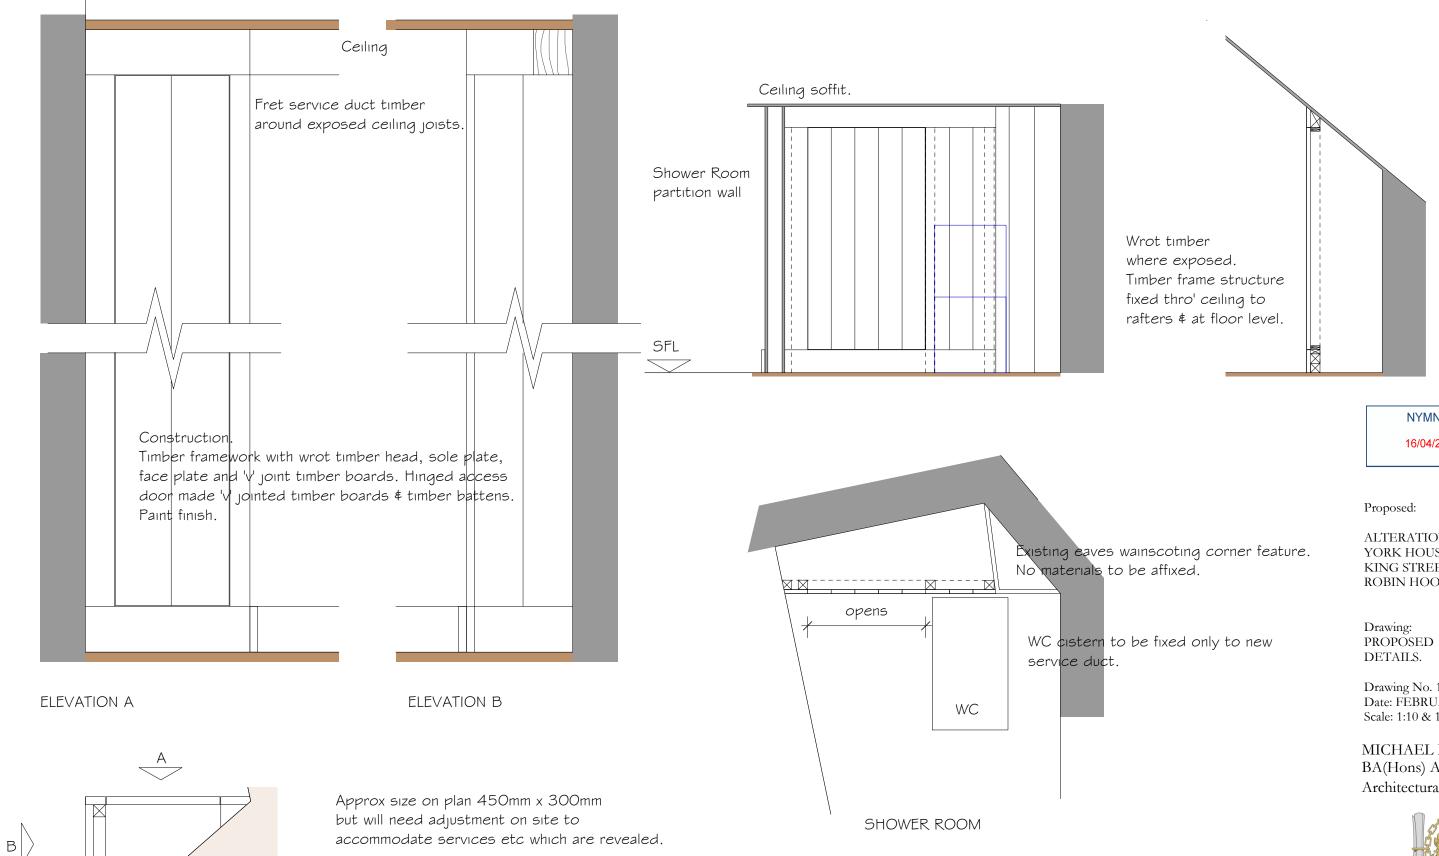
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ALTERATIONS to YORK HOUSE KING STREET ROBIN HOODS BAY

Drawing No. 193/18 Date: FEBRUARY 2018 Scale: 1:10 & 1:20

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DRAWING No.	Bay . DRAWING TITLE Existing Ground Floor Plan	REVISIONS			
193.01					
193.02	Existing First & Second Floor Plans				
193.02	Existing Elevations I				
193.04	Existing Elevations T Existing Side Elevation				
193.10	Ground Floor Plan as Proposed				
193.11	First & Second Floor Plans as Proposed				
193.12	Elevations I as Proposed				
193.13	Side Elevation as Proposed				
193.14	Kitchen Window				
193.15	Second Floor Stairwell Partition				
193.16	SFL Partition Sectional Details				
193.17	External Door (Typical).				
193.18	Detail Sheet				
193	Site Location Plan				

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