



North Elevation unchanged so not shown

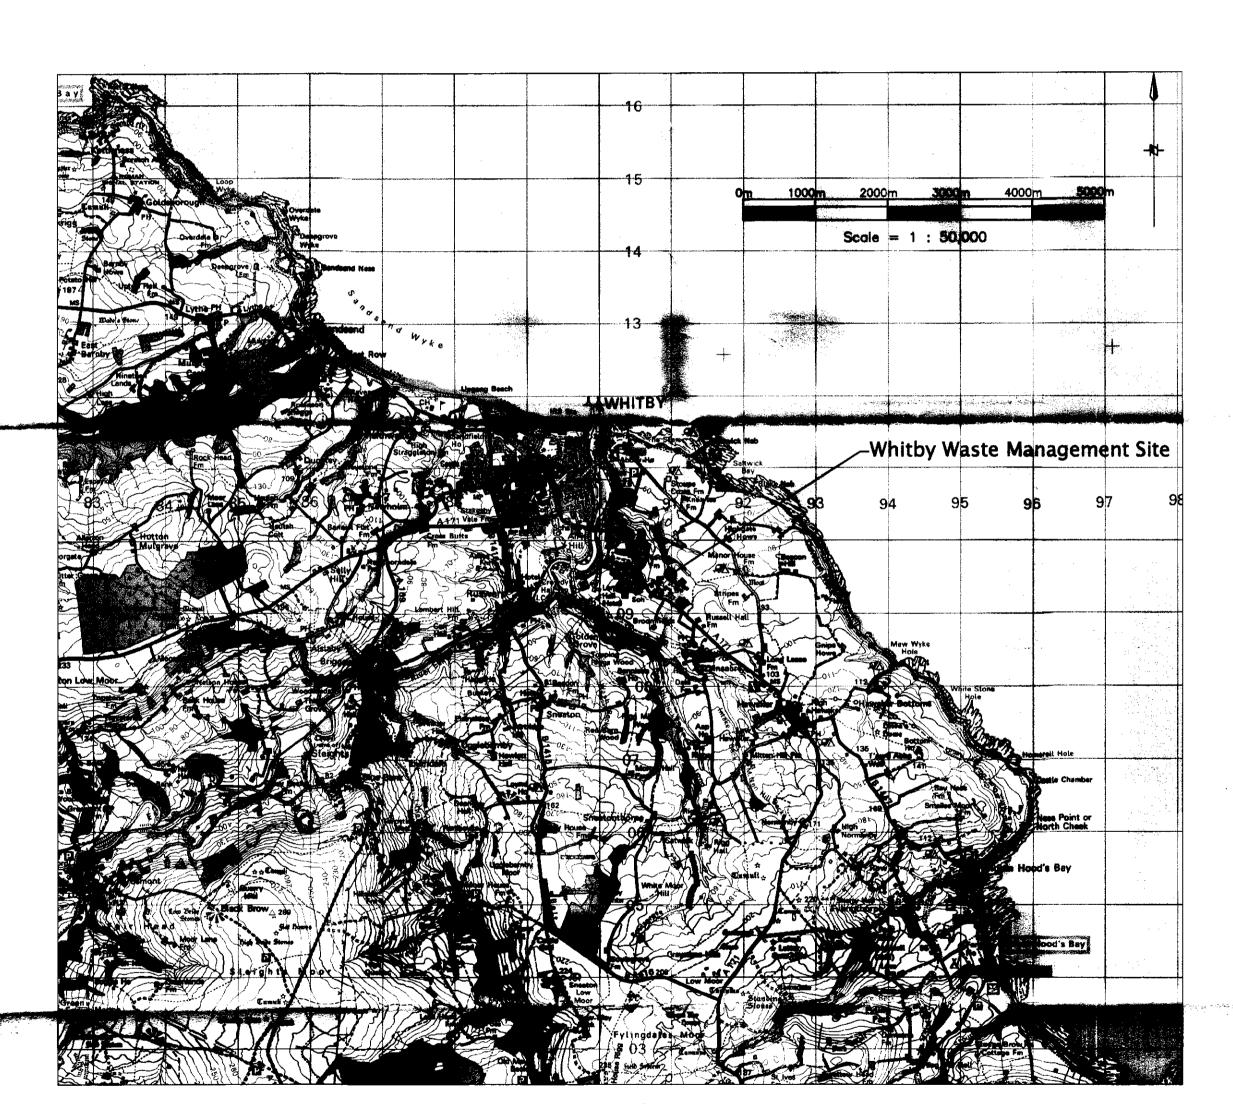


Location Plan
Scale 1:50,000


Site Address
Whitby Waste Management Site
Fairfield Way
Whitby Business Park
Whitby
Y022 4PU
OS Grid Ref: NZ 910 095

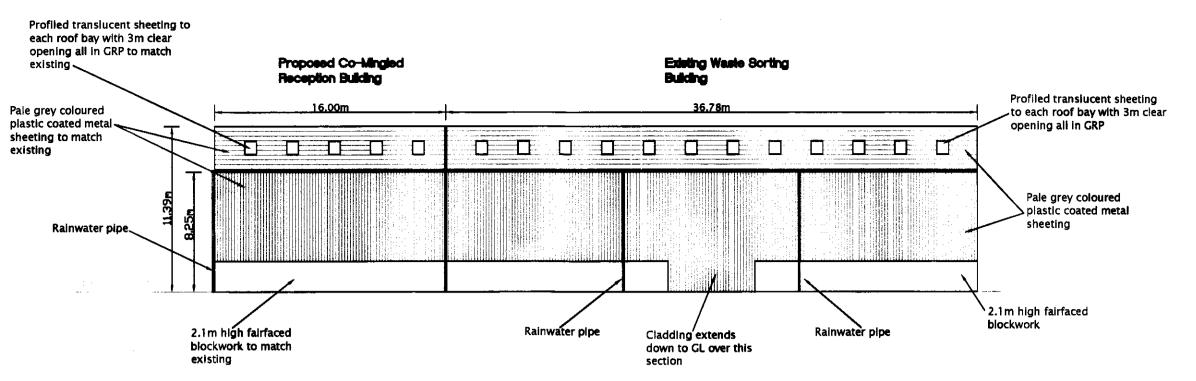

Scale 1:250

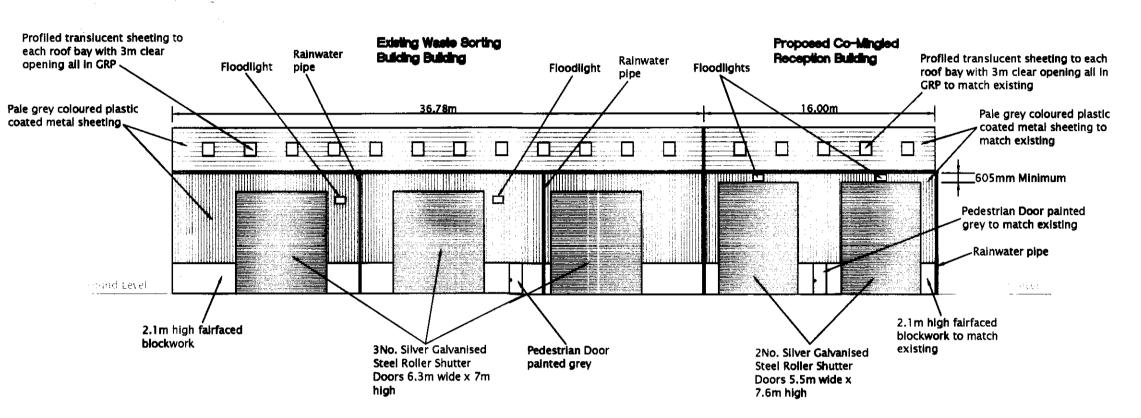

West Elevation
Scale 1:250

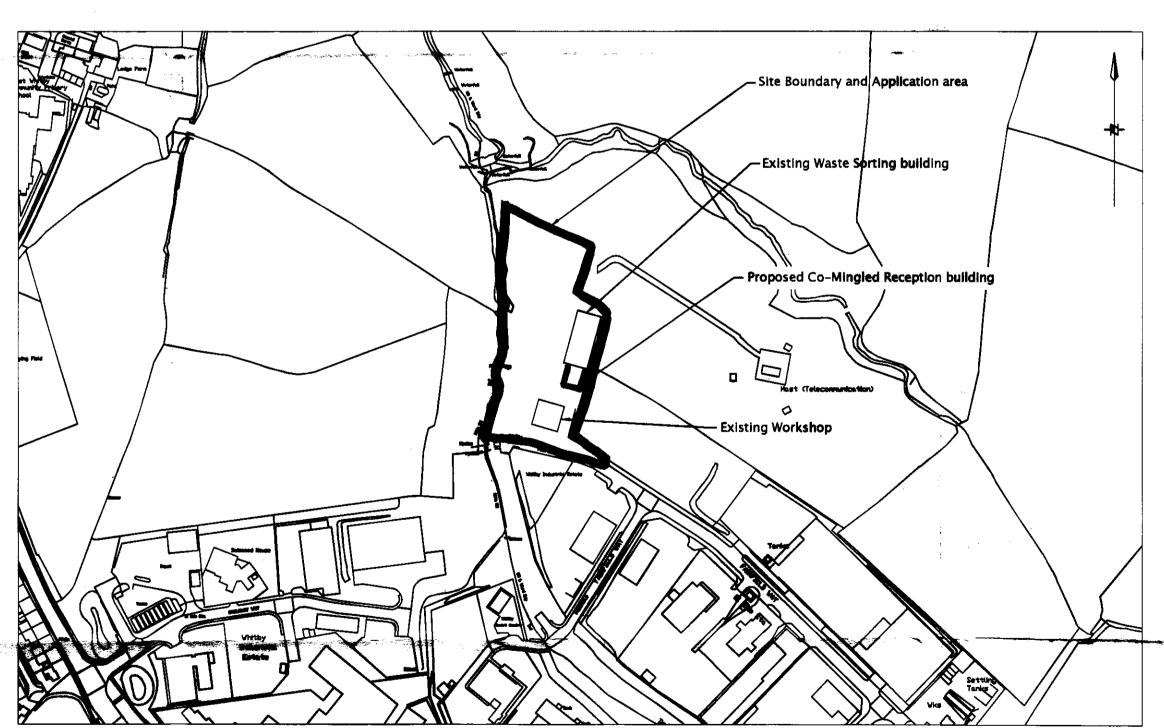

Site Location and Application area

Scale 1:2,500

drawing number

WHI-PL00-Y0901-003

date

11th MAY 2009

note

1. This drawing based on a survey of 8th February 2008 carried out by Dave Jatzuk of MMB on behalf of Yorwaste Ltd and design drawings also completed by MMB.



re	visions	by date			
0	Original drawing.		11.5.09		



YORWASTE LTD.

Mount View
Standard Way
Northallerton
North Yorkshire
DL6 2YD

(c) YORWASTE LT

NOT TO BE COPED OR DETAILS DIVILGED TO THIRD PARTIES EXCEPT WITH PERMISSION OF YORWASTE LTD.

drawing title

WHITBY WASTE MANAGEMENT SITE

PROPOSED CO-MINGLED RECEPTION BUILDING

LOCATION PLANS & ELEVATIONS

A. Clarke
G. O'Keefe
T. Prudom

acales

As Shown

date

11th MAY 2009

drawing number

WHI-PL00-Y0901-003

NZ 90925, 09513



North York Moors National Park Authority The Old Vicarage Bondgate Helmsley York YO62 5BP



Telephone: 01439 770657 Email: dc@northyorkmoors-npa.gov.uk Website: www.moors.uk.net

Application for Planning Permission. Town and Country Planning Act 1990

Publication of applications on planning authority websites.

Please note that the information provided on this application form and in supporting documents may be published on the Authority's website. If you require any further clarification, please contact the Authority's planning department.

1. Applican	t Name, Address and Contact Details		· ·		
Title: Mr	First name: MARK	Surname: HAL			
Company name	YORWASTE LTD				
Street address:	MOUNT VIEW]	Country Code	National Number	Extension
	STANDARD WAY	Telephone number		Namber	Number
		Mobile number:			 7
Town/City	NORTHALLERTON				
County:	NORTH YORKSHIRE	Fax number:	1	AV	
Country:		Email address:		NYMNPA	7
Postcode:	DL6 2YD			3 U SEP 2000	
		○ No			
2. Agent Na	me, Address and Contact Details				
Title: Mr	First Name: CHRIS	Surname: JARV	IS		
Company name:	GLEN KEMP LTD				
Street address:	WETHERBY BUSINESS CENTRE		Country Code	National Number	Extension Number
	14-18 YORK ROAD	Telephone number:			
Town (City		Mobile number:			
	WETHERBY	Fax number:			
	WEST YORKSHIRE	Facall and d		JI	'
	UNITED KINGDOM	Email address:			
Postcode:	LS22 6SL				
3. Description	on of the Proposal				==
EXTENSION TO T	he proposed development including any change of use: HE EXISTING WASTE TRANSFER BUILDING, RELOCATION AND RECORDS OF A VEHICLE WASHING FACILITY AND RECORDS OF	ON OF THE EXTERNA	2011011011		
CONSTRUCTION	OF A VEHICLE WASHING FACILITY AND PROVISION OF	A VEHICLE ACCESS	CKUSHING AND WORK	AND SCREENING OPERA ING AREA.	TION,
	work or change of use already started? Yes Yes				<u></u>

				NYM / 2009 /	n 6 7 5 / F L	4
4. Site Addı	ress Detai	ls			-	
Full postal addre	ess of the site	(including full post	code where available)	Description:		
House:	0	Suffix:				
House name:			MENTAL SERVICES			
Street address:	STAINSACRE	LANE INDUSTRIAL	ESTATE			
	FAIRFIELD W	/AY	ALLEN DE L'AMERICA			
Town/City:	WHITBY					
County:	NORTH YOR	(SHIRE				
Postcode:	Y022 4PU					
Description of lo (must be compl		id reference de is not known):				
Easting:	49096	8				
Northing:	50953	5				
	or prior advice omplete the fo	been sought from	_	out this application? were given (this will help t	es () No he authority to deal with this an	pplication
Title: Ms	First nam	e: ELIZABETH		Surname: WALKER		
Reference:	SITE MI	ETING				
Date (DD/MM/Y)	YYY): 08/07/2	2009 (Must t	e pre-application sub	mission)		
Details of the pr	e-application	advice received:				
DISCUSSIONS F	REGARDING T	HE SUITABILITY OF	THE PROPOSALS AND	INFORMATION TO BE SUE	MITTED IN SUPPORT OF THE A	PPLICATION
Is a new or alter Is a new or alter Are there any new Are there any new	red vehicle ac red pedestriar ew public roac ew public righ	cess proposed to or access proposed to is to be provided wi ts of way to be prov	o or from the public h thin the site? O Ye rided within or adjace	vay? () Yes (No ighway? () Yes (No	-	
If Yes, please pr THE PROPOSALS SITE. Have arrangeme	corporate area covide details: 5 PROVIDE RE	s to store and aid the	· · · · · · · · · · · · · · · · · · ·		GE OF WASTE READY FOR TRAN	NSFER OFF
If Yes, please pr UNDER THE PRO FACILITIES.		CLABLE WASTE WI	LL BE SEPARATED AN	D TRANSPORTED OFF SITE	FOR FURTHER PROCESSING A	T OTHER
8. Neighbou	ır and Cor	nmunity Consu	ultation			
Have you consu	lted you r ne ig	hbours or the local	community about the	proposal? (Yes (No	
(b) an (c) rela	the Authority, nember of sta elected memi ated to a men ated to an ele	I am: ff ber nber of staff	Do any of these s	tatements apply to you?	C Yes ● No	
		ncluding type, colou	r and name) are to b	e used externally (if applica	ble):	

Ref: 04: 3.34

Planning Portal Reference:

000794071

	N\	/M / 2009	/ n 6 7	5 / F L	
10. Materials (continued)	**	, , ,	<u>-</u>		•
Walls - description:					
Description of existing materials and finishes: STEEL CLAD GREY IN COLOUR					····
Description of <i>proposed</i> materials and finishes	•		· ···		
STEEL CLAD GREY IN COLOUR	•				
Roof - description:					
Description of existing materials and finishes:					
STEEL CLAD GREY IN COLOUR					
Description of proposed materials and finishes	•		n 1		
STEEL CLAD GREY IN COLOUR				· - ·· · · · · · · · · · · · · · · · · ·	
Doors - description:					
Description of existing materials and finishes: STEEL ROLLER SHUTTER DOORS					
Description of proposed materials and finishes	······································				
2X STEEL ROLLER SHUTTER DOORS	·				
Boundary treatments - description:	, , , , , , , , , , , , , , , , , , ,				
Description of existing materials and finishes:					
WOODEN FENCE					
Description of proposed materials and finishes:					
PALISADE FENCE WITH ATTACHED LITTER NET	TTING		NYI	MAIPA	
Vehicle access and hard standing - descrip	ption:	1		WNPA	1
Description of existing materials and finishes: COMPACTED SOIL AND RUBBLE			3 U S[? 2009	
			<u> </u>	2000	
Description of proposed materials and finishes: CONCRETE AND TARMAC PLANINGS		L			
Lighting - add description Description of existing materials and finishes: SPOT LIGHTING Description of proposed materials and finishes: SPOT LIGHTING TO SAME CONFIGURATION AS Are you supplying additional information on su If Yes, please state references for the plan(s)/o See Planning Application Supporting Statement Appendix 1 - Design and Access Statement Drawing WHI-PL00-Y0901-001 - Existing Layou Drawing WHI-PL00-Y0901-002A - Proposed Lay Drawing WHI-PL00-Y0901-003 - Location Plans Drawing WHI-PL00-Y0901-004 - Existing Site a Drawing WHI-PL00-Y0901-005 - Proposed Drai	britted plan(s)/drawing(s)/design and access states: it and Application Area yout and Application Area is and Elevations and Drainage Layout	ign and access sta atement:		Yes () No Section	
Please provide information on the existing and	proposed number of on-site par	rking spaces:			
Type of vehicle	Existing number	Total proposed		Difference	
	of spaces	spaces ret	ained)	spaces	
12. Foul Sewage					
Please state how foul sewage is to be disposed	of:				
Mains sewer	Package treatment plant		Unknown		
Septic tank	Cess pit				
Other	,				
					·
Are you proposing to connect to the existing dr	ainage system? 🕝 🔀 🦳	lo (Unknown			
				nlan/a\/d=r=1:-1	- N -
If Yes, please include the details of the existing Fig 4.0 - Drawing WHI-PL00-Y0901-004 - Exist		nngs and state ref	erences for the	pian(s)/drawing(s	s):
Fig 5.0 - Drawing WHI-PL00-Y0901-005 - Propo					
	•	,			

(12 Assessment of Flood Diele	**************************************	•						
13. Assessment of Flood Risk								
Is the site within an area at risk of flooding? (Refer to the Environment Agency's Flood Map showing flood zones 2 and 3 and consult Environment Agency standing advice and your local planning authority requirements for information as necessary.) (Yes No								
If Yes, you will need to submit an appropriate flood risk assessment to consider the risk to the proposed site.								
Is your proposal within 20 metres of a watercourse (e.g. river, stream or beck)? Yes No								
Will the proposal increase the flood risk elsew	here? (Yes (No	·						
How will surface water be disposed of?								
Sustainable drainage system	☐ Main sewe	r.	☐ Pond/lake					
☐ Soakaway		atercourse	<u></u>					
	<u> </u>							
14. Biodiversity and Geological C	onservation			·				
To assist in answering the following questions refer to the guidance notes for further information on when there is a reasonable likelihood that any important biodiversity or geological conservation features may be present or nearby and whether they are likely to be affected by your proposals.								
Having referred to the guidance notes, is then within the application site, OR on land adjacer			affected adversely or co	onserved and enhanced				
a) Protected and priority species	•							
C Yes, on the development site C Yes,	on land adjacent to or	near the proposed deve	lopment	No				
b) Designated sites, important habitats or oth	er biodiversity features							
C Yes, on the development site C Yes,								
c) Features of geological conservation importance								
Yes, on the development site Yes,	on land adjacent to or	near the proposed devel	lopment 🕟 🏲	No				
15. Existing Use								
Please describe the current use of the site:								
WASTE TRANSFER STATION			NYMNE	Ά				
Is the site currently vacant? C Yes	No No No		2 a ced au	nn				
Does the proposal involve any of the following	Does the proposal involve any of the following:							
Land which is known to be contaminated?				·				
Land where contamination is suspected for all								
A proposed use that would be particularly vuln	nerable to the presence	of contamination? (es 🖲 No					
Application advice If you have said Yes to any of the above, you	will need to submit an a	appropriate contamination	on assessment.					
16. Trees and Hedges								
Are there trees or hedges on the proposed dev	velopment site? (Ye	s (No						
And/or: Are there trees or hedges on land adj			uld C v. C No					
influence the development or might be import	•	• • •	Yes No	annlication ann ha				
If Yes to either or both of the above, you will need to provide a full Tree Survey with accompanying plan before your application can be determined. Your Local Planning Authority should make clear on its website what the survey should contain, in accordance with the current 'BS5837: Trees in relation to construction - Recommendations'								
17. Trade Effluent								
Does the proposal involve the need to dispose of trade effluents or waste? Yes No								
18. Residential Units								
Does your proposal include the gain or loss of residential units? Yes No								
19. All Types of Development: No	19. All Types of Development: Non-residential Floorspace							
Does your proposal involve the loss, gain or ch	nange of use of non-resi		Yes No					
Use class/type of use	Existing gross internal floorspace (square metres)	Gross internal floorspace to be lost by change of use or demolition (square metres)	Total gross new internal floorspace proposed (including changes of use) (square metres)	Net additional gross internal floorspace following development (square metres)				

19	All Types o	f Davel	onment: I	Jon.	esidential Flo		/ Zoodini		•	-	· .,
A1	1	Tradable A		1011-1	esiuelitiai Fi	oorspace 	e (contin	uea ;			
A2				-				T	1		
A3	Financial and professional services Restaurants and cafes									0.0	
A4	Drinking establishments							-		0.0	
A5	Hot food takeaways								" 	0.0	
B1 (a)											0.0
B1 (b)	<u> </u>										0.0
B1 (c)		ht industri	· · · · · · · · · · · · · · · · · · ·	<u> </u>							0.0
B2		· · · · · · · · · · · · · · · · · · ·									0.0
B8	<u> </u>	eral indust					•	· · · · · · · · · · · · · · · · · · ·	* /4	ANPA 2009	0.0
ļ	-	e or distrib							157	200.	0.0
C1		d halls of n			···			ļ		2009	0.0
C2		ntial institu		-							0.0
D1		dential inst		· · ·	· · · · · · · · · · · · · · · · · · ·						0.0
D2	Assem	bly and lei	isure	•							0.0
Other								2	24.0		224.0
Other										-,,	
		Total			0.0		0.0		24.0		224.0
For hote	ls, residential i	nstitutions	and hostels,		additionally indic						·
Use Class Types of use						Total rooms proposed (including changes of use)		Net additional rooms			
	C1		otels	0			0		0		
-	C2 Residential institutions						0		0		
	Other Other				0 0			0			
	Outre!					`			<u> </u>		
20. En	nploym en t				-						
If known	, please compl	ete the fol	lowing inform	nation i	regarding employe	ees:					
			Full-tim		Part-time		Ec	quivalent number o	of full-	time	
€:	xisting employ	ees	15		0	- 		15			
Pr	oposed employ	rees	15		0			15			
21 4	urs of Ope										
	•	_									
If known	, please state i	the hours o	of opening for	r each	non-residential us	e proposed	:				
Use	Mon Start Time	day to Frid	lay End Time		Satur Start Time	day End Tir	ne	Sunday and Ba		olidays nd Time	Not Known
Other	07:30:00		7:30:00	+	07:30:00	13:00:0		07:30:00		O (OCCAS	NIOWII
									1500	(0000	
22. Sit	e Area										
What is the site area? 00.87 hectares											
23. Industrial or Commercial Processes and Machinery											
Please describe the activities and processes which would be carried out on the site and the end products including plant, ventilation or air											
conditioning. Please include the type of machinery which may be installed on site: PROCESSES INVOLVING THE SORTING AND TRANSFER OF WASTE MATERIAL											
INSTALLED MACHINERY AND PLANT: CRUSHER SCREEN											
360 EXC	VATOR										

Is the proposal for a waste management development?

Please complete the following table:

● Yes ○ No

23. Industrial or Commercial P	rocesses and Machinery (continued)	
	The total capacity of the void in cubic metres, including engineering surcharge and making no allowance for cover or restoration material (or tonnes if solid waste or litres if liquid waste)	
Transfer stations		46,700
Please give maximum annual operational thr	oughput of the following waste streams:	I
Municipal	26,700	
Construction, demolition and excavation	20,000	
If this is a landfill application you will need to authority should make clear what information	provide further information before your application it requires on its website.	on can be determined. Your waste planning
24. Hazardous Substances		
Is any hazardous waste involved in the propo	osal? (Yes (No	
25. Site Visit		
	Information by the second seco	_
	ic footpath, bridleway or other public land? 🌘 🦞	
	ppointment to carry out a site visit, whom should i	they contact? (Please select only one)
The agent • The applicant • O	ther person	
26. Certificates		
Title: First name: De	Surname: 30/09/2009	☐ Declaration made
26. Certificates (Agricultural Hol	dings Certificate)	
Town and Country Planning Agricultural Land Declaration - (A) None of the land to which the application (B) I have/The applicant has given the requisit	Agricultural Holding Certificate (General Development Procedure) Order 199 relates is, or is part of an agricultural holding. te notice to every person other than myself/the ap	unlicant who can the day 21 days before
Title: First Name:	Surname:	
Person role: Agent Declara	ation date: 30/09/2009	□ Declaration Made
27. Declaration		
I/we hereby apply for planning permission/conform and the accompanying plans/drawings an	sent as described in this additional information.	
Date 30/09/2009		
	-	NYMNPA
		j
	·	3 U SEP 2009
	T	1
	<u> </u>	